City of Carlisle, Iowa
Planning and Zoning Commission
Special Meeting
August 17, 2020
7:00 P.M.
Carlisle City Hall

Join Zoom Meeting - https://us02web.zoom.us/j/9951930479 Meeting ID: 995 193 0479

One tap mobile – Call 1-929-205-6099, enter 995-193-0479# when prompted

We encourage all videoconferencing or calling in to let staff know who you are for the record and then mute your microphone or phone until you would like to speak to provide a better overall experience.

Call to order

Determine quorum

New Business and Action Items

- 1. Discussion and Possible Action on Recommendation for Plat of Survey for Parcel "P" of SW ¼ of the SE ¼ of Section 14, Warren County, Iowa
- 2. Discussion and Possible Action on Special Use Permit for Three Rivers Church at 90 Highway 5
- 3. Discussion and Possible Action on Recommendation for Final Plat for Danamere Farms Plat 8
- 4. Discussion and Possible Action on Recommendation for Preliminary Plat for Pasco Point
- Discussion and Possible Action on Recommendation for Construction Drawings for Pasco Point
- 6. Discussion and Possible Action on Recommendation for Final Plat for Pasco Point
- 7. Discussion and Possible Action on Recommendation for City Hall Site Plan

Administrator/Engineer/Commission Reports

Adjournment

** PLEASE NOTE THAT THIS AGENDA MAY CHANGE UP TO 24 HOURS PRIOR TO THE MEETING **

PREPARED BY: PELDS DESIGN SERVICES - 2323 DIXON STREET, DES MOINES, IOWA 50316 - PH. (515)265-8196

PLAT OF SURVEY

DATE OF SURVEY:

RECORD INDEX:

LOCATION: SECTION 14 TOWNSHIP 77 NORTH RANGE 23 WEST

REQUESTOR: SHAWN O'BRIEN


SITE ADDRESS:


3798 180TH AVENUE

CARLISLE, IA 50047 SURVEYOR: VOLDEMARS PELDS **COMPANY**: PELDS DESIGN SERVICES

RETURN TO:

2323 DIXON STREET DES MOINES, IA 50316

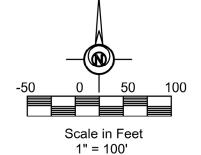

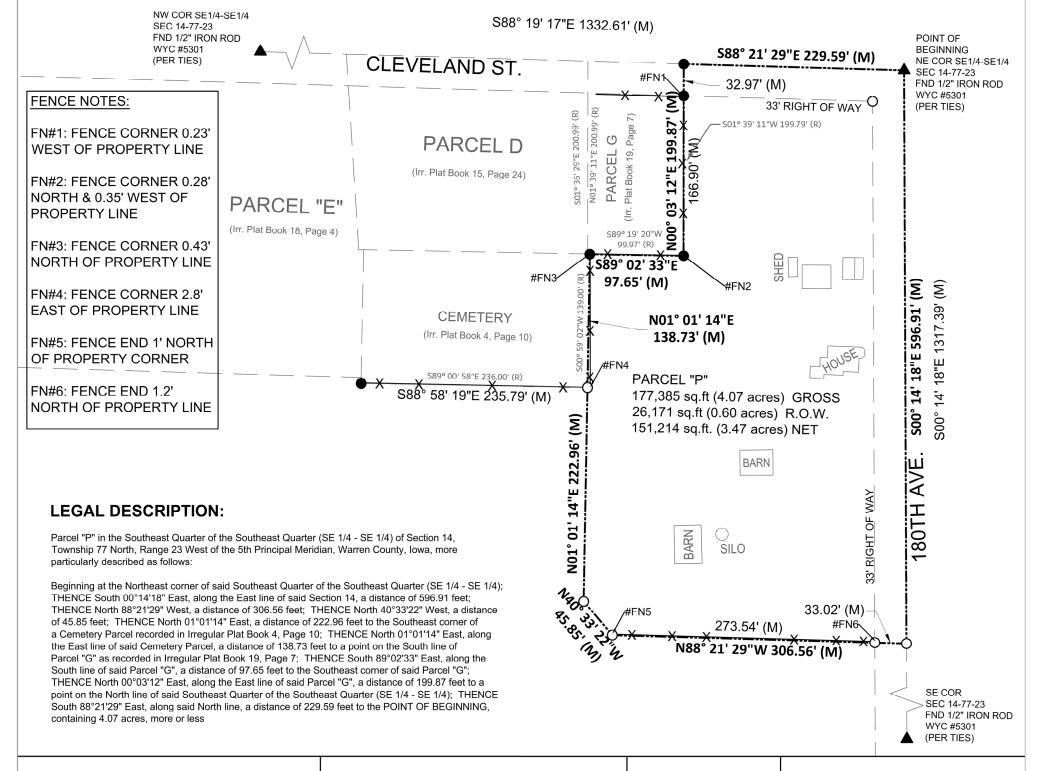

ORIENTATION OF THIS BEARING SYSTEM IS IOWA STATE PLANE SOUTH (NAD 83) THIS SURVEY WAS PERFORMED USING THE IOWA RTN NETWORK.


THIS DRAWING IS BEING MADE AVAILABLE BY PELDS DESIGN SERVICES (P.D.S.) FOR USE ON THIS PROJECT IN ACCORDANCE WITH P.D.S. 'S AGREEMENT FOR PROFESSIONAL SERVICES. P.D.S. ASSUMES NO RESPONSIBILITY OR LIABILITY (CONSEQUENTIAL OR OTHERWISE) FOR ANY USE OF THESE DRAWINGS (OR ANY PART THEREOF) EXCEPT IN ACCORDANCE WITH THE TERMS

I HEREBY CERTIFY THAT THIS LAND SURVEYING DOCUMENT WAS PREPARED AND THE RELATED WORK WAS PERFORMED BY ME OR UNDER MY DIRECT PERSONAL SUPERVISION AND THAT LAM A DULY LICENSED PROFESSIONAL LAND SURVEYOR UNDER THE LAWS OF THE STATE OF IOWA

VOLDEMARS LEO PELDS PLS IA LIC NO 18842 DATE

MY LICENSE RENEWAL DATE IS DECEMBER 31, 2021

ADDITIONAL PAGES OR SHEETS COVERED BY THIS SEAL (NONE UNLESS INDICATED HERE):

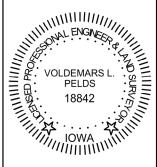

SYMBOLS LEGEND

FND 1/2" IRON ROD WYC #5301 SET 1/2" REROD w/ YELLOW PLASTIC CAP STAMPED #18842

FOUND SECTION CORNER

(M)/(P)/(R) MEASURED/PLATTED/RECORDED

X FENCE

О


WYC WITH YELLOW CAP



PLAT OF SURVEY FOR 3798 180TH AVE. **CARLILE IOWA, 50047**

4	COPYRIGHT DATE:	DRAWN BY:	SCALE:	LATEST REVISION:	PROJECT NO:
		A.BRADFIELD	1" = 100'	7.29.2020	20-082
6	FILE PATH: J:\2020 PROJECTS\20-08	32 - PLAT OF SURVEY - 3798	180TH AVE CARLISLE - O'BRIEN\POS 20	1-082 DWG	

Beacon Warren County, IA

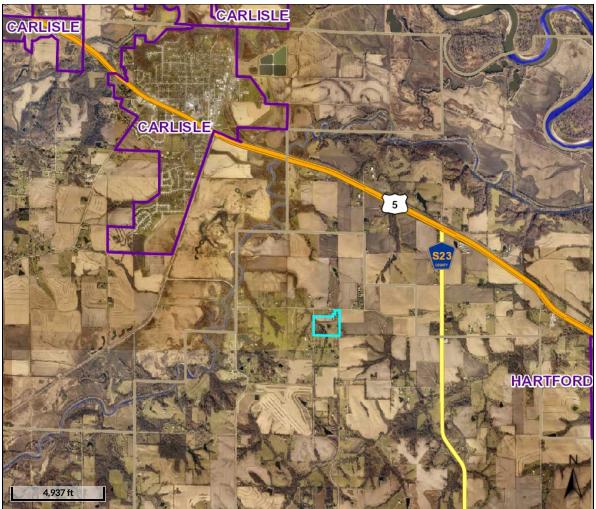

Overview



Legend

Roads

- <all other values>
- Interstate
- Highway
- Ramp
- -- County Gravel
- -- County Level B
- County Level C
- -- City Gravel
- City Street
- Private Street
- Corporate Limits
- Parcels
- Political Township

Major Roads

- County Hwy
- State Hwy
- US Hwy
- Interstate
- Water

Owner Address O'BRIEN, SHAWN/JESSICA

3798 180TH AVE

CARLISLE IA 50047

 Parcel ID
 19000140890
 Alternate ID
 19000140881

 Sec/Twp/Rng
 14-77-23
 Class
 A

Sec/Twp/Rng 14-77-23 Property Address 3798 180TH AVE

CARLISLE

District 19152

Brief Tax Description 14-77-23 SE SE EX 2.43A & EX PCL'S E & G & D

(Note: Not to be used on legal documents)

Acreage

Disclaimer:

30.19

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Date created: 8/6/2020 Last Data Uploaded: 8/5/2020 9:30:25 PM






CITY OF CARLISLE, IOWA SPECIAL USE PERMIT APPLICATION


(Please print. Any Non-Legible Application Can Be Rejected.)

1.	\$50.00 Fee Receipt No
2.	Applicant: Three Rivers Community Church
3.	Legal Description: Church / Religious Organization
4.	Present Zoning: Commercial
5.	Present Use: Empty / Former Edward Jones
6.	Proposed Use: Church: meeting place for worship, youth group, small group, etc
7.	List Owners of all Property Within 300 feet of area for which the special use permit pertains. At Least 50 Percent of Property Owners within 300 Feet of Area to be Must Sign Petition (Use Extra Sheet if Needed)
Pri	ated Name Address Signature
Te	nny Crane 100 As h St Lot 71 Chy Cin
Z,	want her 100 Ash St Lot 18 Torrent loca
L	cesa Castiffo 100 Ash st #52 Deesa Castiffo
9	Leio Corwonski 100 Ash St #80 SRQU
r	16++ Thie 120 Huy 5 regite
7	on ting 69 AsH Tom ting

120.00	
_	
89	
8.	Attach a narrative describing required information as described on the attached page
9.	Attach a drawing or plat showing the location, dimensions and use(s) of the applicant's property and all properties within 500' of the property. Please include all streets, alleys, railroads, utility easements and other physical features.
DA	APPLICANT'S SIGNATURE

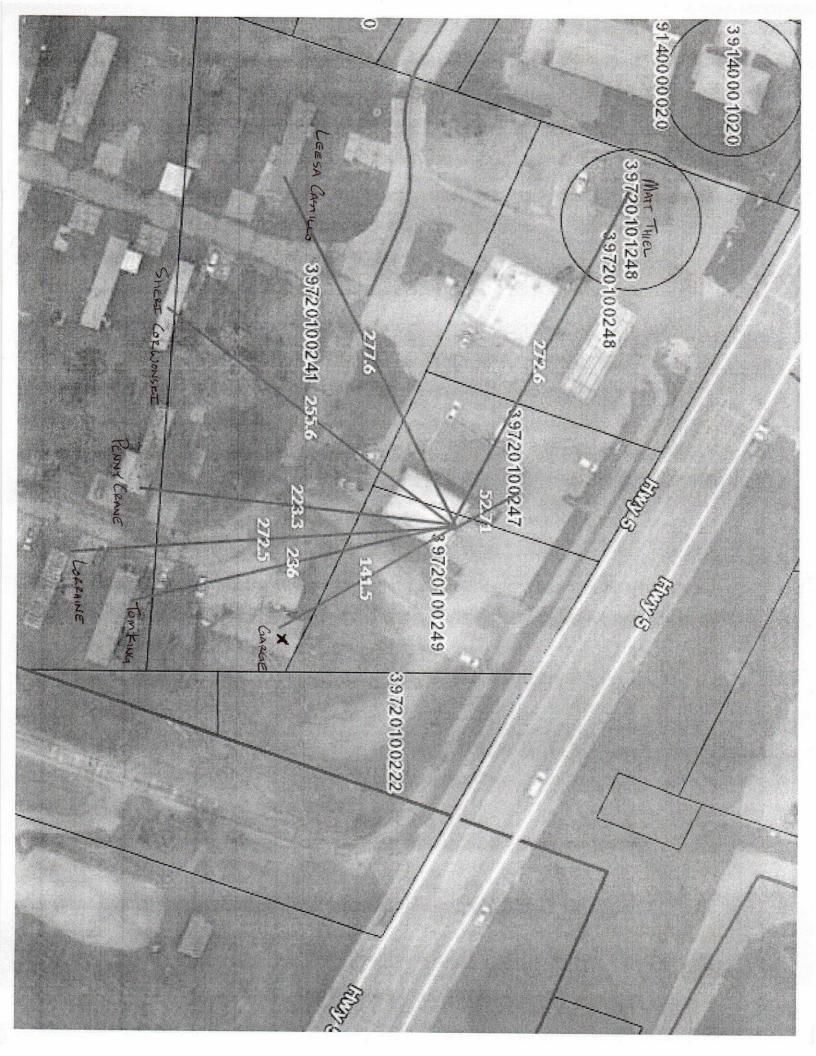

Beacon Warren County, IA

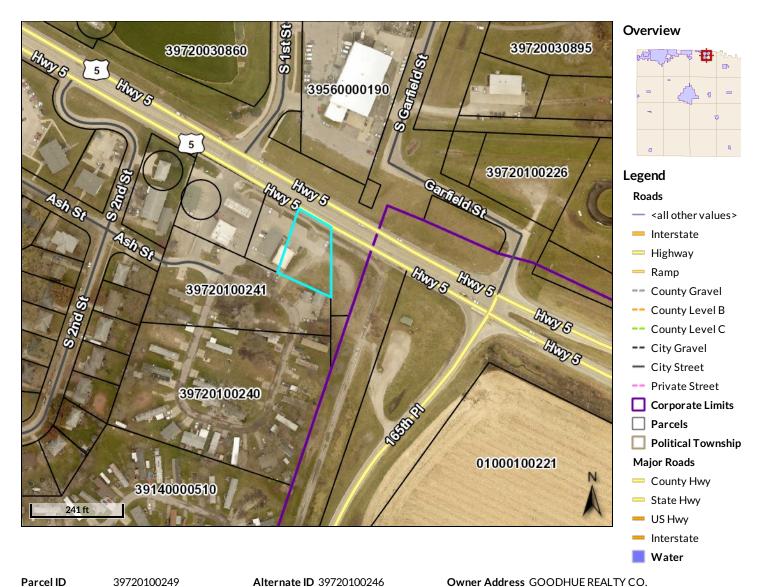

 Parcel ID
 39720100249

 Sec/Twp/Rng
 10-77-23

 Property Address
 80/90 HWY 5

 CARLISLE

Class C

Acreage n/a

Owner Address GOODHUE REALTY CO. 8944 180TH AVE CARLISLE IA 50047

District 39100

Brief Tax Description 10-77-23.45A E OF PCL N NW NE

(Note: Not to be used on legal documents)

Disclaimer:

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Date created: 8/13/2020 Last Data Uploaded: 8/12/2020 9:27:07 PM



Aspen Business Park 414 South 17th Street, Suite 107 Ames, Iowa 50010

August 13, 2020

Caleb Smith, P.E.

McClure Engineering Company 1360 NW 121st Street Clive, Iowa 50325

Danamere Farms Plat 8 - Final Plat

Carlisle, Iowa FOX Ref No: 8666-03C.239

Thank you for submitting your project for review. The City is committed to assisting you with the completion of this project. FOX Engineering and the City Staff has completed the second review for Danamere Farms Plat 8 Final Plat, dated August 6, 2020 and as submitted to FOX Engineering via email on August 11, 2020 and offers the following comments:

- 1. General notes for P&Z and Council: The plat is for R-3 (Multi-Family Townhome) as per the approved Danamere PUD Master Plan.
- 2. Please provide easement documents to be recorded for each off-site easement required for this development (Sanitary Sewer Easement and Storm Sewer Easement...possibly flowage/detention easement). These easements will need to be vacated in the future when future phases are platted.
- 3. 180.09.03.A, please provide a warranty deed to the City properly executed for all street intended as public streets and any other property intended for public use.
- 4. 180.09.03.B, please submit any covenants or restrictions to be imposed upon the plat. These should be the Final Development Plan Documents that have already been approved that defines the by-laws of the common areas that are NOT dedicated to the City. These documents need to be recorded in the office of the County Recorder.
- 5. 180.09.03.D, please provide a certificate by the Owner that the subdivision is free of consent and is in accordance with the desires of the owner.
- 6. Please provide an Easement Dedication document which states the restrictions on the easements (ex. sanitary sewer easements, storm sewer easements, PUE's) as shown on the Final Plat. McClure has prepared and sent these in the past for previous plats. This document should be recorded with the Final Plat.
- 7. As-built record drawings shall be submitted within 30 days after the completion of construction. The Engineer shall field verify all structures (manholes, valves, hydrants) and flowlines.
- 8. Please provide maintenance bonds for all pavement and utilities to be dedicated to the city of Carlisle. The bond period shall begin once all infrastructure is installed and accepted. City Engineer shall review the bond amounts prior to submission of for bond documents. Maintenance Bonds for this plat are as follows (180.03, 15):

a. Streets -4-yr Maintenance Bond b. Sanitary Sewers - 2-yr Maintenance Bond c. Storm Sewers - 2-yr Maintenance Bond d. Water Mains - 2-yr Maintenance Bond e. Sidewalks -4-yr Maintenance Bond 9. Please provide performance bonds for all incomplete construction. Please provide an opinion of cost for City review prior to submittal of the performance bond.

FINAL PLAT SCHEDULE:

PLANNING & ZONING: August 17, 2020 at 7:00 at the Carlisle City Hall

COUNCIL MEETING: August 24, 2020 at 6:30 at the Carlisle City Hall


If you have any questions or concerns, please contact Mitch Holtz at 515-231-6005. The City reserves the right to modify or add to these comments.


FOX ENGINEERING ASSOCIATES, INC.

Mitch Holtz, P.E.

Copy to: Deven Markley, City Administrator, Carlisle



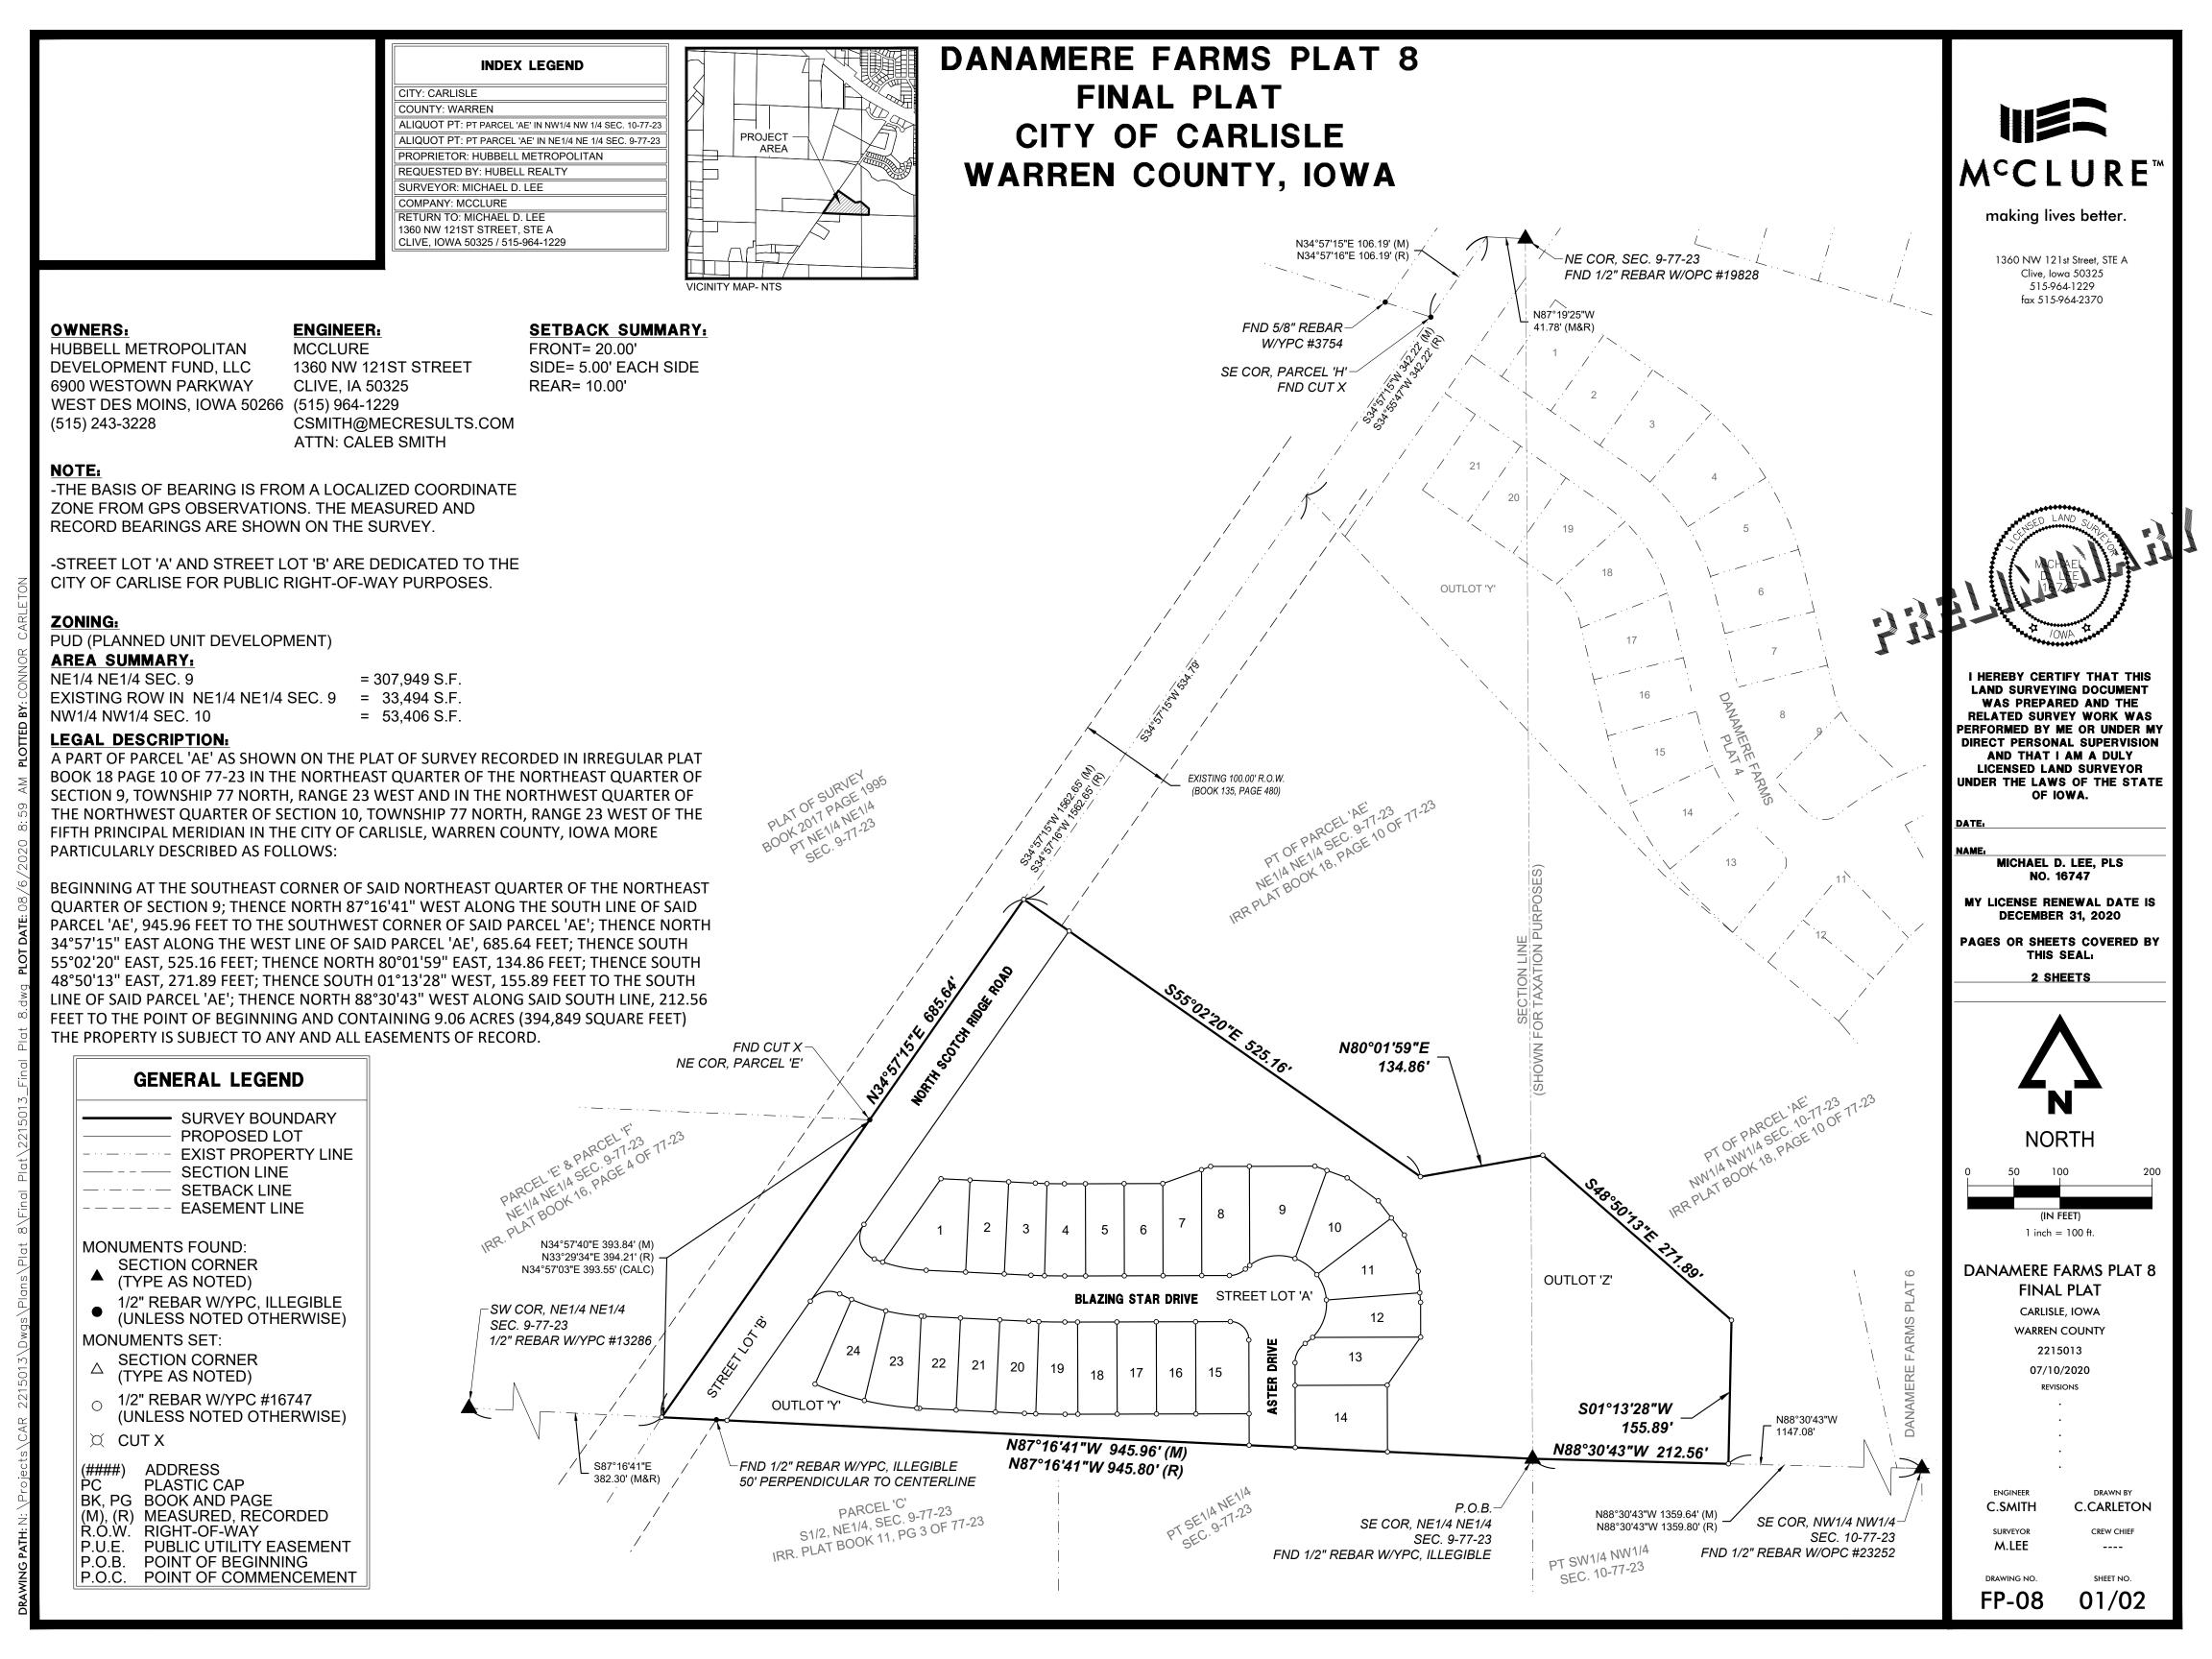

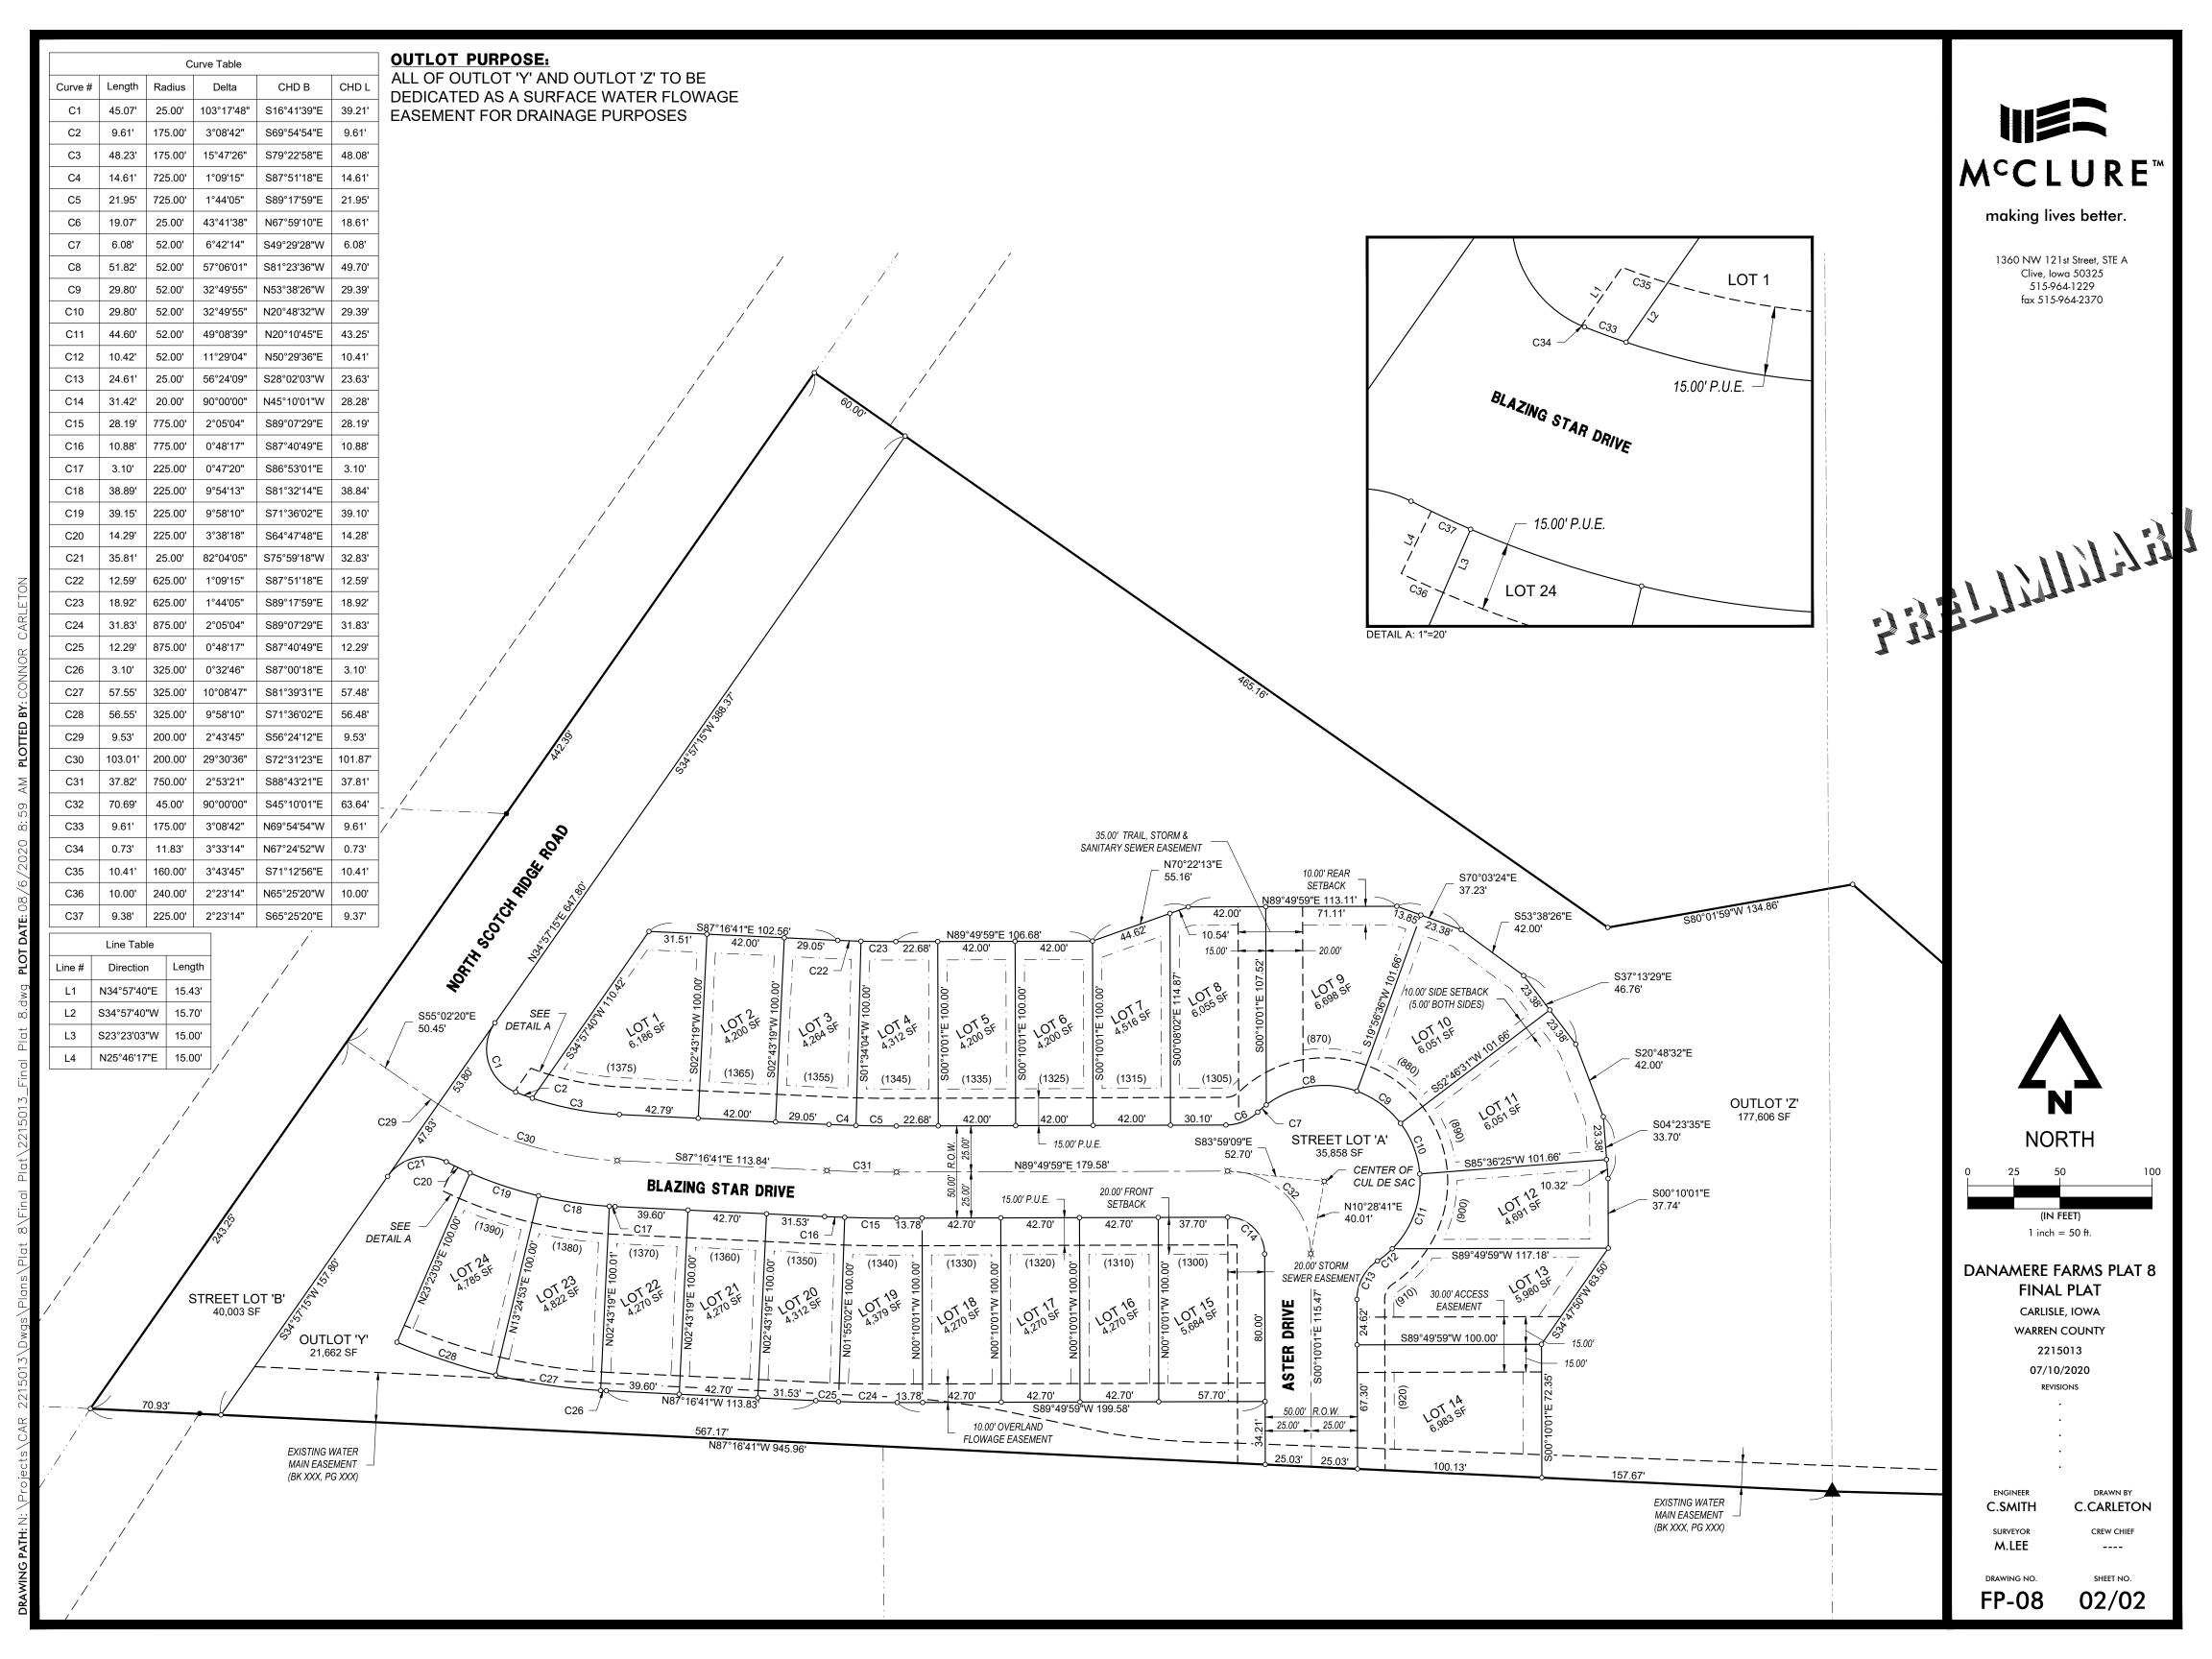



August 13, 2020

Brad Kuehl

Bishop Engineering Company, Inc. 3501 104th Street Des Moines, IA 50322

RE: Pasco Point - Preliminary Plat Review

Carlisle, Iowa

FOX Ref No: 8666-20C.210

Thank you for submitting your project for review. The City is committed to assisting you with the completion of this project. FOX Engineering and the City Staff have completed the second review for the Preliminary Plat for Pasco Point, dated 8/11/20, and have the following comments:

- 1. The land in this development appears as "Conservation Development" in the Future Land Use plan. The estate lots proposed in this development appear to be a good fit per the Features and Location Criteria described in the Future Land Use Plan. This land use calls for densities less than one unit per acre.
- 2. The Developer has requested waivers for the following items:
 - a. Curb and Gutter (as required by 180.07(2)) To allow a rural street cross section.
 - b. Storm Water Detention (as required by 180.07(3)) to allow the site to discharge without detention.
 - c. Sidewalks (as required by 180.07(5)) To eliminate sidewalks from the development.
- 3. FOX Engineering has forwarded the proposed Preliminary Plat to the State DOT to verify whether they have jurisdictional comments since the access for the development comes from Highway 5. They have no further comments beyond requiring a permit for work within the State right of way.
- 4. 180.05(3), FOX has reviewed the proposed lot layout in relation to the Comprehensive Plan, Zoning Requirements and Subdivision Requirements and have no further comments.
- 5. 180.05(5) & 180.07, FOX has reviewed the proposed street network in relation to the Comprehensive Plan, Zoning Requirements and Subdivision Requirements and have the following comments:
 - a. **Discussion is necessary** regarding the naming of the proposed street (Pasco Point Court).
 - b. As per 180.07 (2): Curb and gutter shall be required on all streets.
 - i. The Developer has requested a waiver to allow the use of a rural cross-section (no curb and gutter with ditches in lieu of storm sewer).
 - ii. FOX can support the proposed roadway cross section in this instance as it would be in line with the Conservation Development Land Use as per the Comprehensive Plan.
 - iii. Discussion is necessary whether the waiver shall be granted for curb and gutter.
- 6. 180.07(8), FOX has reviewed the proposed water main within this development in relation to the Comprehensive Plan, Zoning Requirements and Subdivision Requirements and have no further comments.

- 7. 180.07(2), FOX has reviewed the proposed storm sewer within this development in relation to the Comprehensive Plan, Zoning Requirements and Subdivision Requirements and have the following comments:
 - a. Please provide a certified storm water management plan that clarifies the existing and proposed discharges that will be leaving the site. Note that the SWMP must contain a statement that no downstream detriment to properties will occur as part of this development, citing calculations accordingly.
 - b. As per 180.07(3): Detention shall be required (storm drainage plan shall be per the Design Standards Manual).
 - i. The Developer has requested a waiver to allow undetained storm water flows from the proposed subdivision.
 - ii. FOX can support the proposed concept of having no detention for this development as the lots are large and will add a minor percentage of imperviousness to the area. Also, storm sewer would be contrary to the Conservative Development Land Use per the Comprehensive Plan.
 - iii. **Discussion is necessary** whether the waiver shall be granted for detention.
- 8. 180.07(5), FOX Engineering has reviewed the proposed bike paths and sidewalks within this development in relation to the Comprehensive Plan, Zoning Requirements and Subdivision Requirements and have the following comments:
 - a. The proposed development and the Comprehensive Plan do not show any parks or trails in this portion of the proposed preliminary plat.
 - b. As per 180.07(5): Sidewalks shall be required.
 - i. The Developer has requested a waiver of the sidewalk requirement.
 - ii. FOX can support the proposed concept eliminating concepts for the rural cross section roadway in this instance as it would be in line with the Conservation Development Land Use as per the Comprehensive Plan.
 - iii. The Council shall determine whether the Developer shall grade and allow for a future sidewalk along Highway 5.
 - iv. <u>Discussion is necessary</u> whether the waiver should be granted for installation of sidewalks for this plat:
 - 1. Along Highway 5
 - 2. Along the cul-de-sac
- 9. 180.07(6), FOX has reviewed the proposed sanitary sewer within this development in relation to the Comprehensive Plan, Zoning Requirements and Subdivision Requirements and have the following comments:
 - a. Since the plat boundaries exceed 200-ft from the nearest public sanitary sewer, it is acceptable to allow for private sewage treatment systems for this plat.
 - b. As per 180.07(6) Any plat that cannot reasonably be served by public sewer shall show results of soil percolation tests made by the Engineer preparing the plat. Such tests shall be in accordance with the Warren County Board of Health. The designing engineer shall furnish the City with three certified copies of as-built plans and certify that the facilities have been installed in accordance with the plans and specifications. As-built plans shall specifically show service line stub locations.
 - i. The Developer has requested that the percolation tests be provided at a later date as thy are not currently available.
 - ii. FOX can support the proposed concept of having the approval of the development be subject to review and acceptance of the Soil Percolation tests and results.



FOX Engineering <u>recommends approval</u> of the Preliminary Plat for Pasco Point, subject to acceptance of the percolation test results, and contingent to discussion regarding waivers per above.

PRELIMINARY PLAT REVIEW SCHEDULE:

PLANNING & ZONING: August 17, 2020 at 7:00pm at the Carlisle City Hall

COUNCIL MEETING: August 24, 2020 at 6:30pm at the Carlisle City Hall

If you have any questions or concerns, please contact Mitch Holtz at (515) 231-6005. The City reserves the right to add or modify these comments.


FOX ENGINEERING ASSOCIATES, INC.

Mitch Holtz, P.E.

CC: Deven Markley, City Administrator



Beacon Warren County, IA

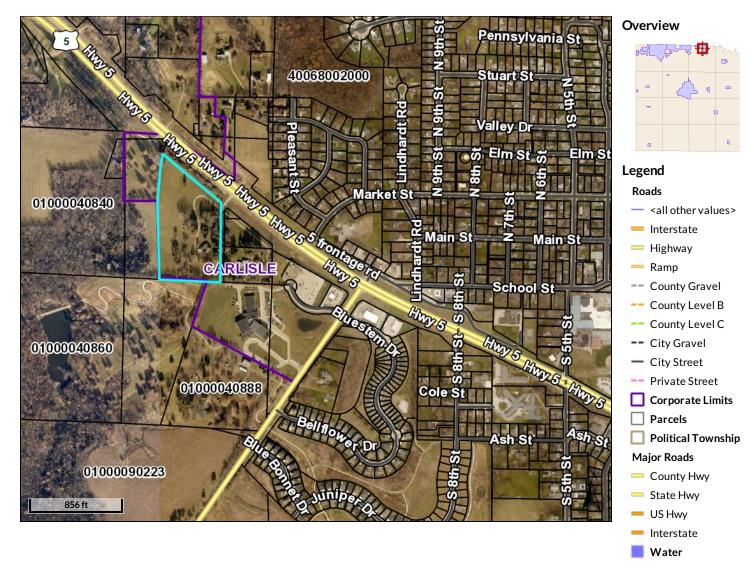

 Parcel ID
 39720040825
 Alternate ID
 39800040820/40000040820
 Owner Address
 PASCO STORAGE UNLIMITED INC

 Sec/Twp/Rng
 4-77-23
 Class
 R
 PO BOX 66027

Property Address 1584 HWY 5 Acreage n/a WEST DES MOINES IA 50265

CARLISLE

District 39100

Brief Tax Description 4-77-23 CARLISLE LAND IN SEC PT NESES OF HWY EX 4.06AC NW COR & EX 35' STRIP BEG 428.4' W SE COR BEG

428.5' W SE COR NE SE LAND ON 40000040820

(Note: Not to be used on legal documents)


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SCALE: 1' = 1,000'

		CU	IRVE TABLE		
CURVE	LENGTH	RADIUS	CHORD	BEARING	DELTA
C1	165.92	130.00	154.88	N87°50'08.37"W	73°07'35"
C2	29.86	50.00	29.42	N72°42'33.37"E	34°12'59"
C3	73.63	65.00	69.76	S57°21'49.78"W	64°54'26"
C4	55.87	65.00	54.17	S00°17'09.32"W	49°14'55"
C5	55.87	65.00	54.17	S48°57'45.77"E	49°14'55"
C6	55.87	65.00	54.17	N81°47'19.13"E	49°14'55"
C7	62.53	65.00	60.15	N29°36'10.86"E	55°07'21"
C8	67.54	40.01	59.80	S50°24'14.72"W	96°42'28"
C9	37.57	70.00	37.12	N66°38'51.69"W	30°45'02"

ABBREVIATIONS:

CONCRETE DEEDED DISTANCE **EXISTING ENCLOSURE** FINISHED FLOOR

FLOW LINE **FRACTIONAL** MEASURED DISTANCE MANHOLE ORANGE PLASTIC CAP PLATTED DISTANCE

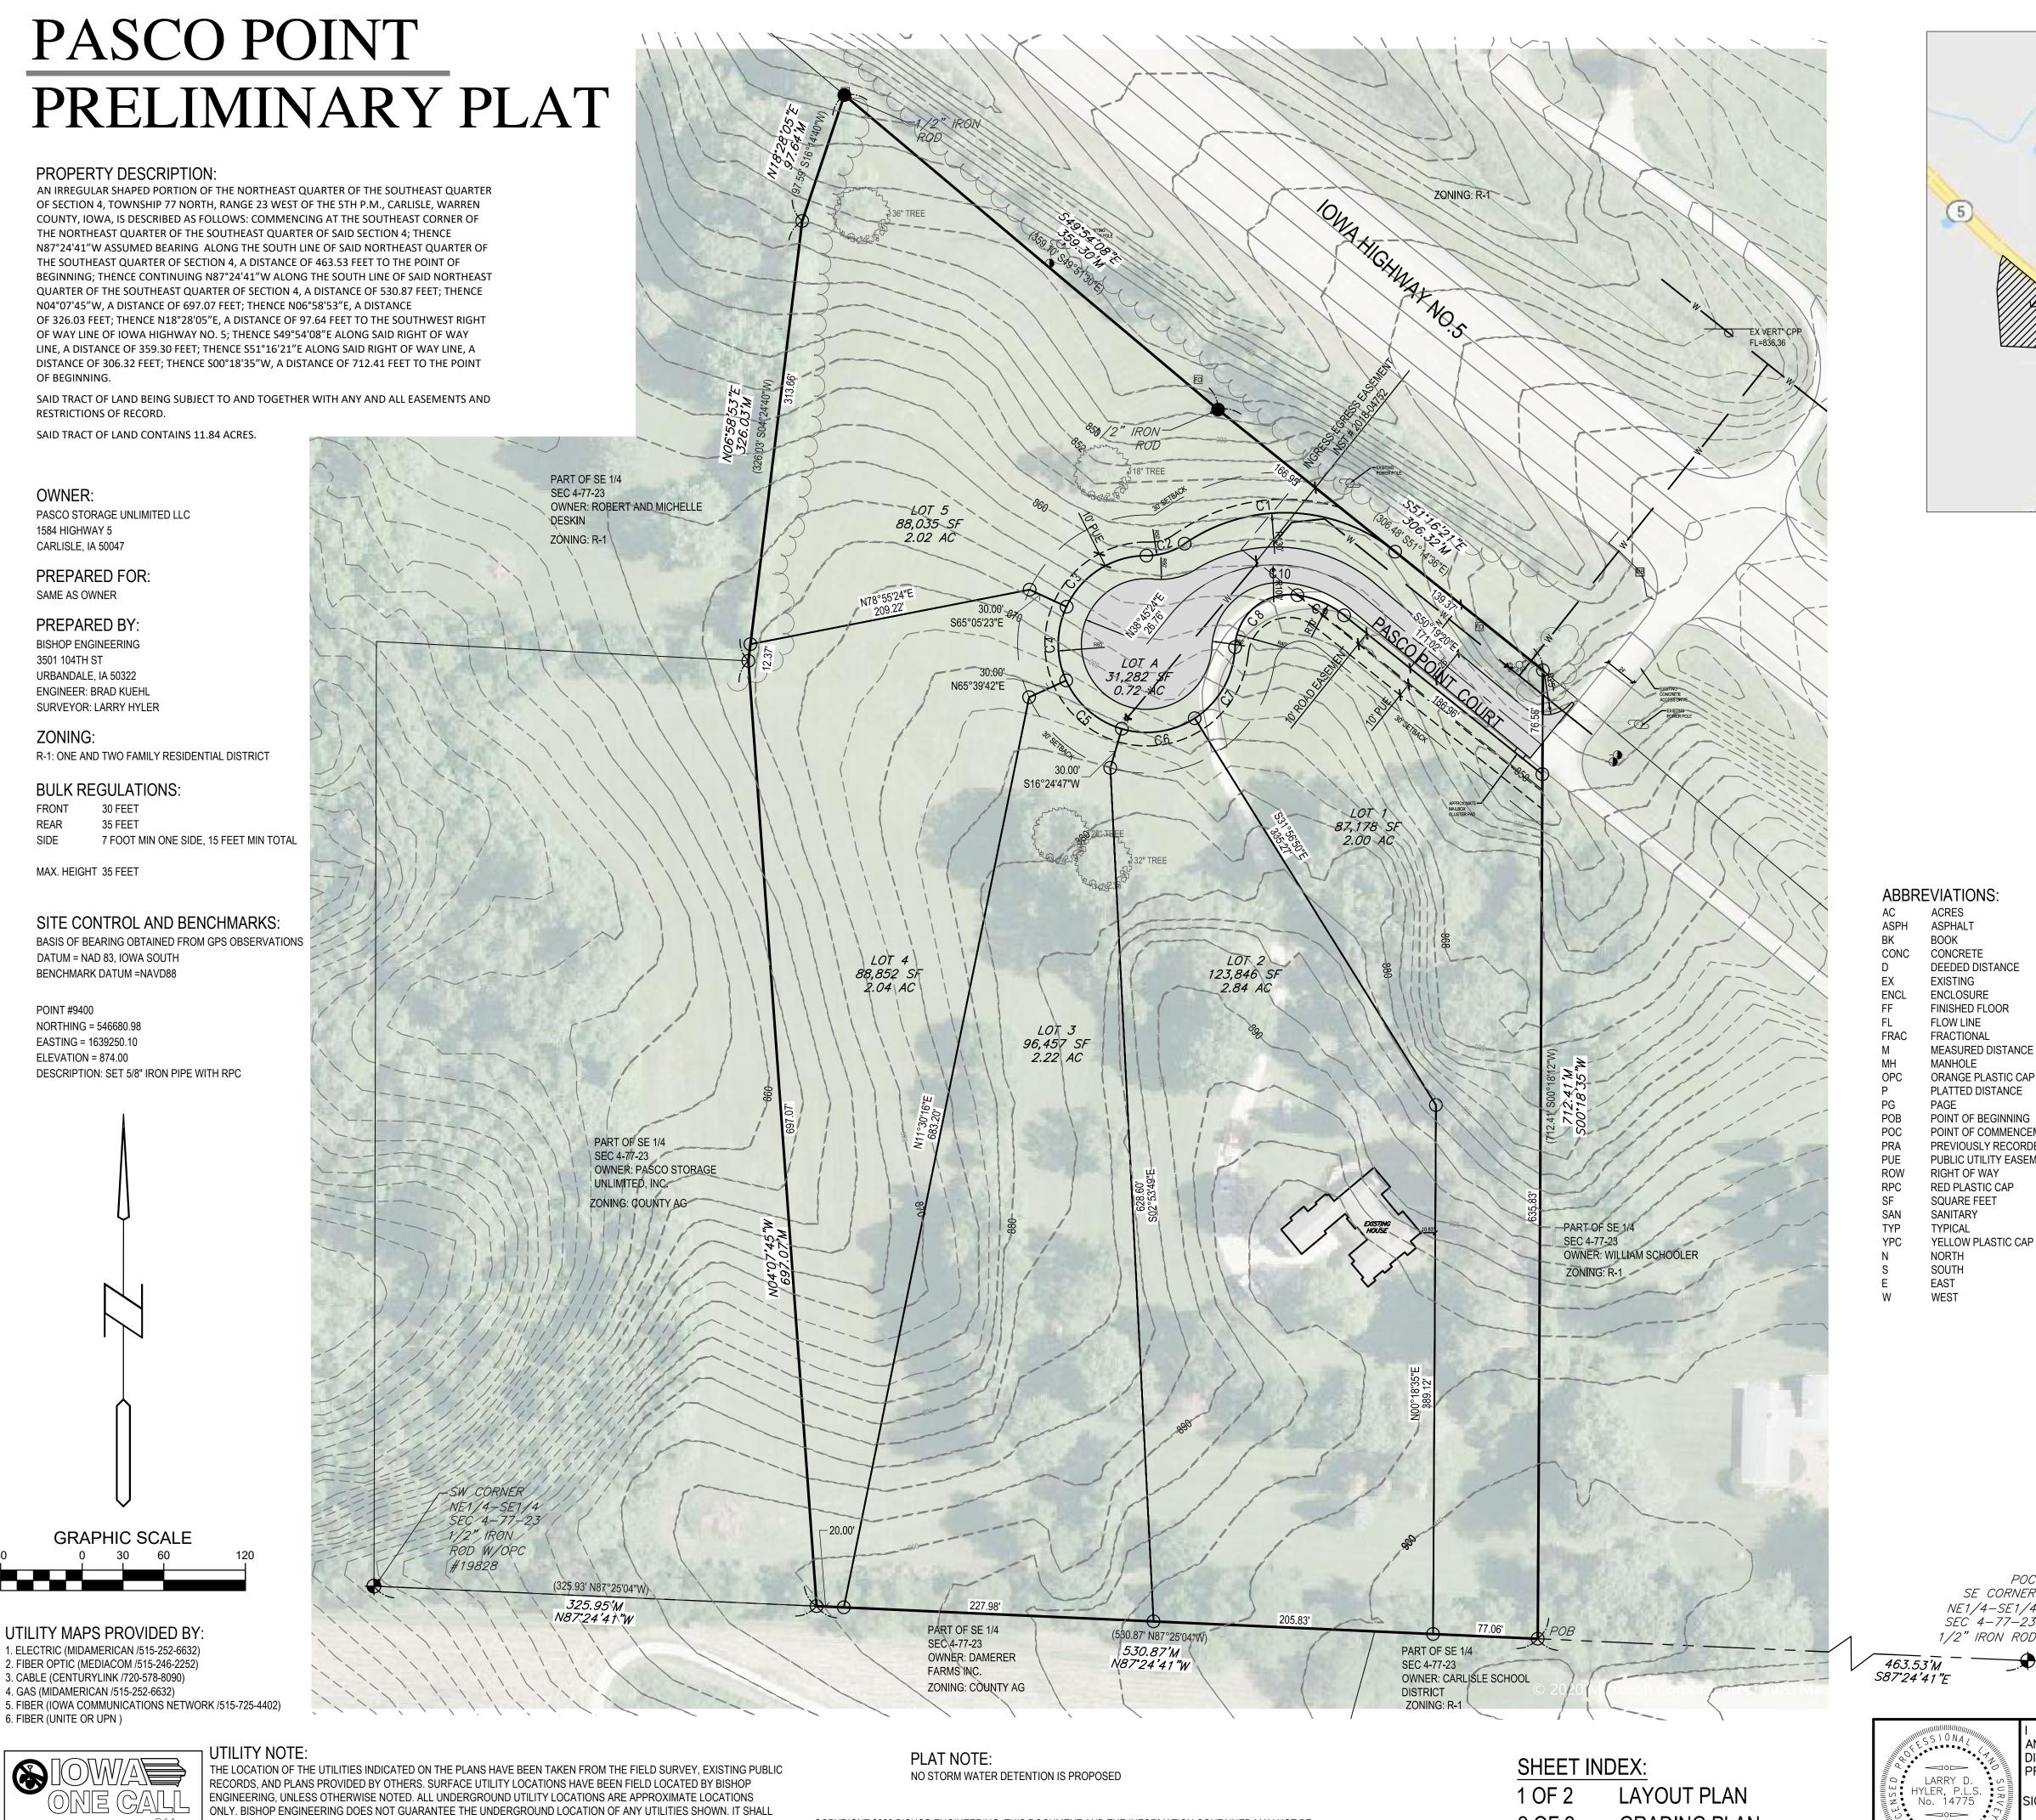POINT OF BEGINNING POINT OF COMMENCEMENT PREVIOUSLY RECORDED AS PUBLIC UTILITY EASEMENT RIGHT OF WAY RED PLASTIC CAP SQUARE FEET

LEGEND: — SAN — SANITARY SEWER

— ST — STORM SEWER — W — WATER LINE — G — GAS LINE — U/E — UNDERGROUND ELECTRIC — O/E — OVERHEAD ELECTRIC

— TELE — TELEPHONE LINE — F/O — FIBER OPTIC — CATV — CABLE TV

 STORM MANHOLE CURB INTAKE SURFACE INTAKE

FLARED END SECTION S SANITARY MANHOLE © CLEANOUT FIRE HYDRANT

SPRINKLER irrigation control valve WATER MANHOLE

W WELL WATER VALVE ™ WATER SHUT OFF X YARD HYDRANT

E ELECTRIC MANHOLE ELECTRIC METER E ELECTRIC RISER

ELECTRIC VAULT D POWER POLE

TRANSFORMER POLE ELECTRIC JUNCTION BOX

ELECTRIC PANEL

- GUY WIRE GAS METER

GAS VALVE AIR CONDITIONING UNIT

> TELEPHONE VAULT TELEPHONE MANHOLE TRAFFIC SIGNAL MANHOLE

FIBER OPTIC RISER FIDER OPTIC FAULT ⊸ SIGN

1 OF 2

7 DENOTES NUMBER OF PARKING STALLS PROPERTY CORNER - FOUND AS NOTED SECTION CORNER - FOUND AS NOTED

ALL SIDE YARD SETBACKS ARE INTENDED
TO BE USED TO CONVEY STORM WATER
FROM THE SUBJECT LOT AND ANY ADJACENT LOTS

SURVEY NOTES: THIS PLAT HAS AN ERROR OR CLOSURE OF LESS THAN 1.0 FEET IN 10,000.0 FEET. EACH LOT WITHIN THIS PLAT HAS AN ERROR OF CLOSURE OF LESS THAN 1.0 FEET IN 5,000.0 FEET.

ALL CORNERS HAVE BEEN PLACED WITH A 3/4 INCH IRON PIPE UNLESS NOTED OTHERWISE. ALL CORNERS PLACED HAVE A YELLOW PLASTIC IDENTIFICATION CAP NO. 14775.

LOT 'A' IS A STREET LOT AND WILL BE DEEDED TO THE CITY OF CARLISLE.

SE CORNER NE1/4-SE1/4 SEC 4-77-23 1/2" IRON ROD

HEREBY CERTIFY THAT THIS LAND SURVEYING DOCUMENT WAS PREPARED AND THE RELATED SURVEY WORK WAS PERFORMED BY ME OR UNDER MY DIRECT PERSONAL SUPERVISION AND THAT I AM A DULY LICENSED PROFESSIONAL LAND SURVEYOR UNDER THE LAWS OF THE STATE OF IOWA. PROJECT NUMBER:

∑0

 $\overline{\mathbf{C}}$

 \triangleleft

REFERENCE NUMBER:

DRAWN BY:

CHECKED BY:

REVISION DATE:

7/27/2020 CITY#1

8/11/2020 CITY#2

OF 2

BE THE DUTY OF THE CONTRACTOR TO DETERMINE THE LOCATION AND DEPTH OF ANY UNDERGROUND UTILITIES SHOWN AND IF ANY ADDITIONAL UTILITIES, OTHER THAN THOSE SHOWN ON THE PLANS, MAY BE PRESENT. A REQUEST WAS MADE

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GRADING PLAN

LARRY I No. 14775

LARRY D. HYLER, P.L.S. 14775


ICENSE RENEWAL DATE: DEC. 31, 2020

PAGES OR SHEETS COVERED BY THIS SEAL:

SHEET NUMBER:

1-800-292-8989

TO IOWA ONE CALL FOR UTILITY PROVIDERS TO VERIFY, LOCATE, AND MARK THEIR UTILITIES IN THE FIELD.

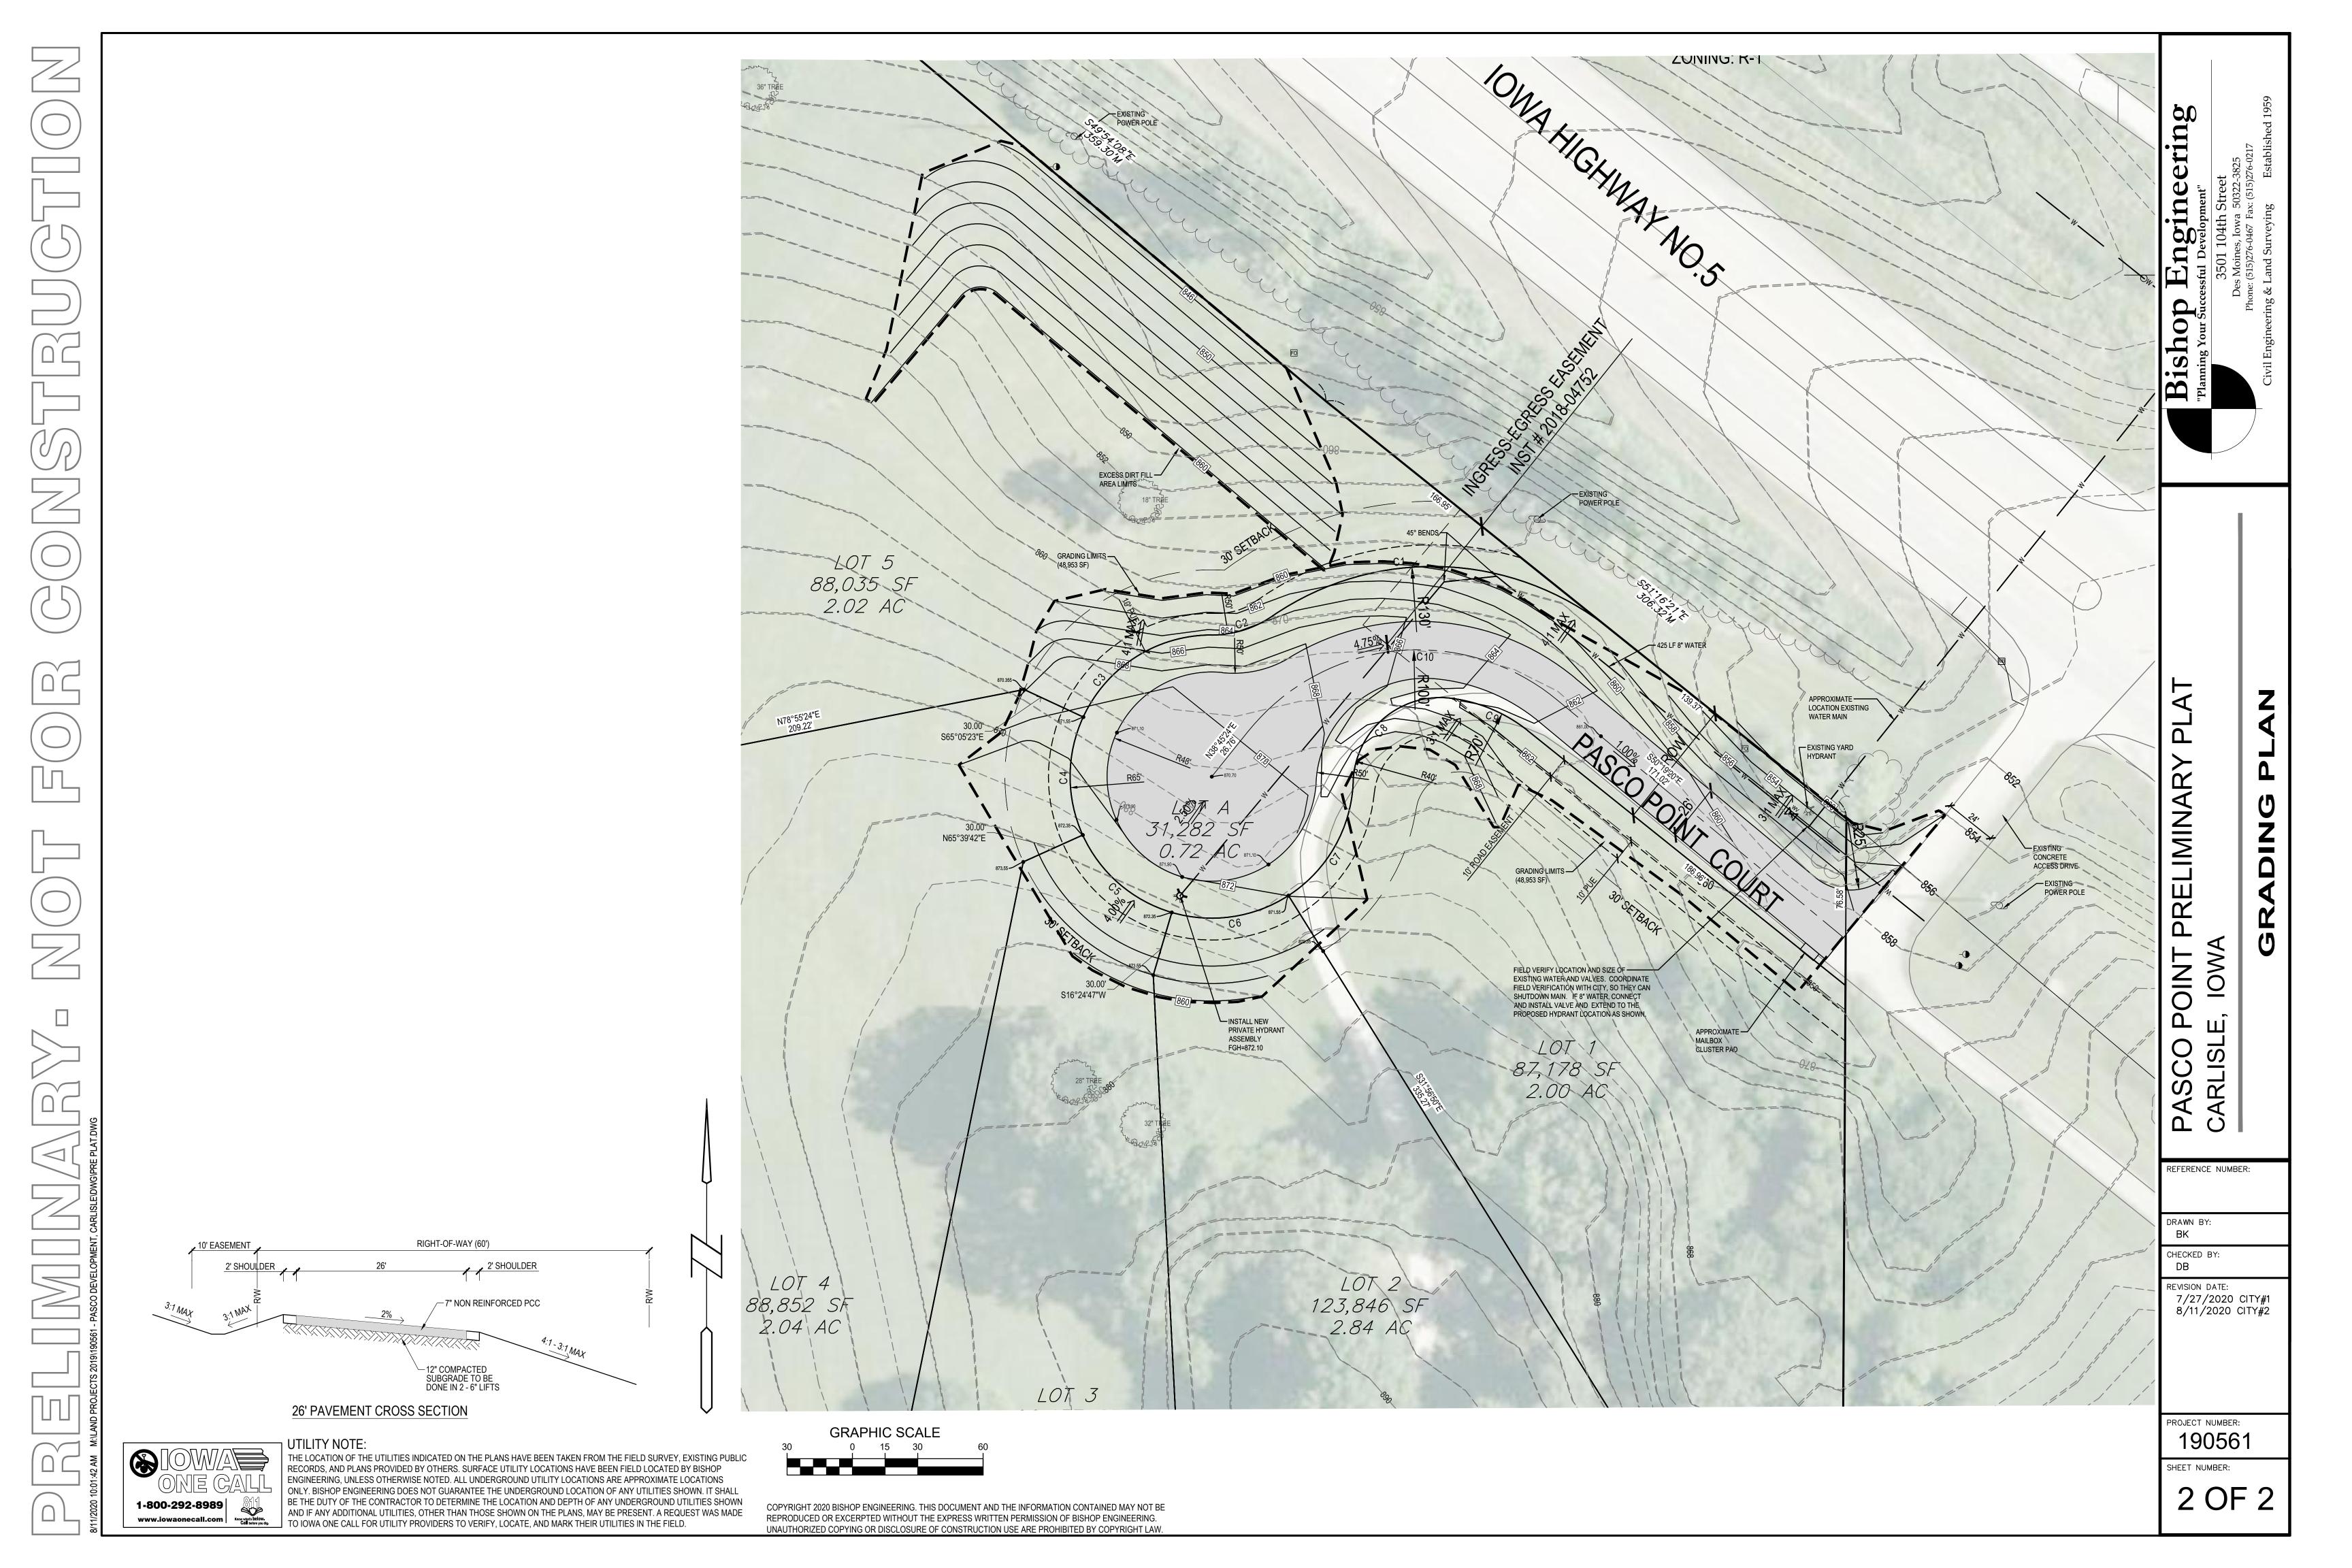



August 13, 2020

Brad Kuehl

Bishop Engineering Company, Inc. 3501 104th Street Des Moines, IA 50322

RE: Pasco Point - Construction Plan Review Carlisle, Iowa

FOX Ref No: 8666-20C.250

FOX Engineering has completed the second review for of the Pasco Point Construction Plans, dated August 11, 2020 and offer the following comments:

Construction Plan - General

- 1. This review is subject to review/approval of the Pasco Point Preliminary Plat, dated 8/11/20, and any
- 2. The IDNR Water Permit has been submitted for review. Further comments, as necessary, will be submitted under separate cover.
- 3. Please provide results of soil percolation tests as per 180.07(6) of the Code, and in accordance with the Warren County Board of Health, when they become available.
- 4. Please provide a geotechnical report that addresses pavement thickness, backfilling and subsurface drainage with provided recommendations.

Sheet 1 - Construction Drawing

- 5. Please show addresses for the lots. These will be provided by the City prior to filing the final plat.
- 6. **Discussion is necessary** regarding the naming of the street (Pasco Point Court).
- 7. Public works shall review the locations of the proposed curb stops. Any comments will be forthcoming under separate cover.
- 8. Please provide a street sign for this development.

Lighting

9. Please provide a street lighting plan.

SWPPP Narrative and Erosion Control Plan

10. FOX has yet to review the SWPPP and erosion control plan. Further comments, if any, will be submitted under separate cover.

Storm Water Management Report

11. FOX has yet to review the SWMP. Further comments, if any, will come under separate cover. It is understood that a waiver for detention is being sought from Council.

FOX Engineering recommends approval of the Construction Drawings for Pasco Point, subject to approval of the Pasco Point Preliminary Plat (and any waivers granted) and submittal of a geotechnical report, and subject to acceptance of the percolation test results.

CONSTRUCTION PLAN REVIEW SCHEDULE:

PLANNING & ZONING: August 17, 2020 at 7:00pm at the Carlisle City Hall

COUNCIL MEETING: August 24, 2020 at 6:30pm at the Carlisle City Hall

If you have any questions or concerns, please contact Mitch Holtz at (515) 231-6005. The City reserves the right to add or modify these comments.

FOX ENGINEERING ASSOCIATES, INC.

Mitch Holtz, P.E.

CC: Deven Markley, City Administrator





August 10, 2020

Honorable Mayor, City Council and Plan and Zoning Commission 195 N. 1st Street Carlisle, Iowa 50047 ATTN: Deven Markley

Re: Waiver Request

Pasco Point – 1584 Highway 5 (BE #190561)

Dear Honorable Mayor, City Council and Plan and Zoning Commission Members:

On behalf of Paige Williams, we respectfully request a permanent waiver of storm water detention, curb and gutter and sidewalks per City Code Section 180.07 for the proposed Pasco Point development to be located at 1584 Highway 5.

The Pasco Point development contains approximately 11.84 acres and is being proposed as a large lot subdivision, limited to five single-family lots. The land is shown as "Conservation Development" in the City's Future Land Use Plan and calls for densities less than one unit per acre. With five lots, the density is under half of that at 0.42 units/acre. As a large-lot, conservation type development, open spaces and preservation of the natural terrain and drainage is encouraged, so this development includes a short public street access to a cul-de-sac. The street is proposed as a rural section with shallow ditches in lieu of curb and gutter to maintain existing drainage patterns and direct surface water to the open ditches allowing more opportunities for natural storm water management.

With the short section of street including a shallow open ditch, five large lots and currently no sidewalks or bike paths along the Highway 5 corridor in this area, we do not feel sidewalks are necessary for this development.

We appreciate your time and consideration of this waiver request and look forward to any further discussion at your regular meetings. Please do not hesitate to contact me if you have any questions or concerns.

Respectfully Submitted,

Brad Kuehl, Project Manager Bishop Engineering

PASCO POINT CONSTRUCTION DRAWING

SHEET INDEX:

COVER SHEET

LAYOUT AND GRADING PLAN 2 OF 4

PLAN AND PROFILE - WATER

4 OF 4 SWPPP

PROPERTY DESCRIPTION:

AN IRREGULAR SHAPED PORTION OF THE NORTHEAST QUARTER OF THE SOUTHEAST QUARTER OF SECTION 4, TOWNSHIP 77 NORTH, RANGE 23 WEST OF THE 5TH P.M., CARLISLE, WARREN COUNTY, IOWA, IS DESCRIBED AS FOLLOWS: COMMENCING AT THE SOUTHEAST CORNER OF THE NORTHEAST QUARTER OF THE SOUTHEAST QUARTER OF SAID SECTION 4; THENCE N87°24'41"W ASSUMED BEARING ALONG THE SOUTH LINE OF SAID NORTHEAST QUARTER OF THE SOUTHEAST QUARTER OF SECTION 4, A DISTANCE OF 463.53 FEET TO THE POINT OF BEGINNING; THENCE CONTINUING N87°24'41"W ALONG THE SOUTH LINE OF SAID NORTHEAST QUARTER OF THE SOUTHEAST QUARTER OF SECTION 4, A DISTANCE OF 530.87 FEET; THENCE N04°07'45"W, A DISTANCE OF 697.07 FEET; THENCE N06°58'53"E, A DISTANCE OF 326.03 FEET; THENCE N18°28'05"E, A DISTANCE OF 97.64 FEET TO THE SOUTHWEST RIGHT OF WAY LINE OF IOWA HIGHWAY NO. 5; THENCE S49°54'08"E ALONG SAID RIGHT OF WAY LINE, A DISTANCE OF 359.30 FEET; THENCE S51°16'21"E ALONG SAID RIGHT OF WAY LINE, A DISTANCE OF 306.32 FEET; THENCE S00°18'35"W, A DISTANCE OF 712.41 FEET TO THE POINT

SAID TRACT OF LAND BEING SUBJECT TO AND TOGETHER WITH ANY AND ALL EASEMENTS AND RESTRICTIONS OF RECORD.

SAID TRACT OF LAND CONTAINS 11.84 ACRES

OWNER:

PASCO STORAGE UNLIMITED LLC 1584 HIGHWAY 5 CARLISLE, IA 50047

PREPARED FOR: SAME AS OWNER

PREPARED BY **BISHOP ENGINEERING** 3501 104TH ST

URBANDALE, IA 50322 **ENGINEER: BRAD KUEHL** SURVEYOR: LARRY HYLER

R-1: ONE AND TWO FAMILY RESIDENTIAL DISTRICT

SETBACKS:

35 FEET SIDE

7 FOOT MIN ONE SIDE, 15 FEET MIN TOTAL

SITE CONTROL AND BENCHMARKS:

BASIS OF BEARING OBTAINED FROM GPS OBSERVATIONS DATUM = NAD 83, IOWA SOUTH BENCHMARK DATUM =NAVD88

POINT #9400 NORTHING = 546680.98 EASTING = 1639250.10 ELEVATION = 874.00 DESCRIPTION: SET 5/8" IRON PIPE WITH RPC

UTILITY MAPS PROVIDED BY: 1. ELECTRIC (MIDAMERICAN /515-252-6632)

- 2. FIBER OPTIC (MEDIACOM /515-246-2252) 3. CABLE (CENTURYLINK /720-578-8090)
- 4. GAS (MIDAMERICAN /515-252-6632) 5. FIBER (IOWA COMMUNICATIONS NETWORK /515-725-4402)
- 6. FIBER (UNITE OR UPN)

1-800-292-8989

GENERAL NOTES:

- 1. ALL WORK SHALL BE DONE IN ACCORDANCE WITH CARLISLE STANDARD SPECIFICATIONS FOR PUBLIC IMPROVEMENTS AND SUDAS STANDARD SPECIFICATIONS AND ANY AND ALL CITY/COUNTY SUPPLEMENTAL SPECIFICATIONS. THE CITY OF CARLISLE MUST BE NOTIFIED BY ALL CONTRACTORS 48 HOURS PRIOR TO
- 2. IN EVENT OF A DISCREPANCY BETWEEN THE QUANTITY ESTIMATES AND THE DETAILED PLANS, THE DETAILED PLANS SHALL GOVERN.
- 3. THE CONTRACTOR SHALL BE RESPONSIBLE FOR THE LOCATION OF ALL UTILITIES. ANY DAMAGE TO SAID UTILITIES SHALL BE REPAIRED AT THE CONTRACTORS
- 4. ALL WORK SHALL BE DONE IN ACCORDANCE WITH THE CURRENT O.S.H.A. CODES AND STANDARDS. NOTHING INDICATED ON THESE PLANS SHALL RELIEVE THE CONTRACTOR FROM COMPLYING WITH THE APPROPRIATE SAFETY REGULATIONS.
- 5. ALL NECESSARY CONSTRUCTION SIGNS, BARRICADES AND OTHER TRAFFIC CONTROL DEVICES REQUIRED DURING CONSTRUCTION WILL BE FURNISHED BY THE CONTRACTOR. SIGNS, BARRICADES AND OTHER TRAFFIC CONTROL DEVICES MUST BE IN CONFORMANCE WITH THE "MANUAL ON UNIFORM TRAFFIC CONTROL DEVICES FOR STREETS AND HIGHWAYS."
- 6. BISHOP ENGINEERING SHALL NOT BE LIABLE FOR ANY INJURIES THAT HAPPEN ON SITE. THIS SHALL INCLUDE BUT NOT BE LIMITED TO TRENCH COLLAPSES FROM VARYING SOIL CONDITIONS OR INJURIES CAUSED BY UNDERGROUND UTILITIES INCLUDING UTILITIES THAT ARE NOT SHOWN ON PLAN.
- 7. THE CONTRACTOR IS LIABLE FOR ALL DAMAGES TO PUBLIC OR PRIVATE PROPERTY CAUSED BY THEIR ACTION OR INACTION IN PROVIDING FOR STORM WATER FLOW DURING CONSTRUCTION. DO NOT RESTRICT FLOWS IN EXISTING DRAINAGE CHANNELS, STORM SEWER, OR FACILITIES.
- 8. THE CONTRACTOR SHALL SUBMIT TO THE ENGINEER A SCHEDULE FOR PERFORMANCE OF WORK ITEMS. THIS SCHEDULE SHALL BE PROVIDED BY THE CONTRACTOR AT THE PROJECT PRECONSTRUCTION CONFERENCE. NO WORK SHALL BEGIN UNTIL A SCHEDULE HAS BEEN SUBMITTED AND ACCEPTED. THE CONTRACTOR SHALL THEN PERFORM WORK TO CONFORM TO THE ACCEPTED SCHEDULE.
- 9. LABORATORY TESTS SHALL BE PERFORMED BY THE OWNER UNLESS OTHERWISE NOTED. THE CONTRACTOR SHALL PROVIDE SAMPLES OF MATERIAL REQUIRED FOR LABORATORY TESTS AND TESTING IN ACCORDANCE WITH THE URBAN STANDARD SPECIFICATIONS FOR PUBLIC IMPROVEMENTS
- 10. SOIL IMPORT OR EXPORT ON THIS PROJECT SHALL BE CONSIDERED INCIDENTAL AND WILL NOT BE MEASURED OR PAID FOR SEPARATELY
- 11. THE CONTRACTOR SHALL PROTECT ALL STRUCTURES NOT SHOWN AS REMOVALS ON THE PLANS.
- 12. THE CONTRACTOR SHALL OBTAIN ANY AND ALL NECESSARY PERMITS PRIOR TO ANY CONSTRUCTION. CONTRACTOR SHALL WORK WITH OWNER OR OWNERS
- REPRESENTATIVE ON ALL REQUIRED STORM WATER DISCHARGE PERMITS FROM THE IOWA DEPARTMENT OF NATURAL RESOURCES AND THE CITY OF CARLISLE. 13. GRADING AND EROSION CONTROL SHALL BE DONE IN ACCORDANCE WITH THE APPROVED GRADING PLAN, SWPPP, NPDES DOCUMENTS, AND IOWA
- DEPARTMENT OF NATURAL RESOURCES REQUIREMENTS. 14. THE CONTRACTOR SHALL PICK UP ANY DEBRIS SPILLED ONTO THE ADJACENT RIGHT OF WAY OR ABUTTING PROPERTIES AS THE RESULT OF CONSTRUCTION, AT
- THE END OF EACH WORK DAY AND PRIOR TO A RAIN EVENT. 15. THE CONTRACTOR IS RESPONSIBLE FOR THE PROMPT REMOVAL OF ALL MUD THAT HAS BEEN TRACKED OR WASHED UNTO ADJACENT PROPERTY OR RIGHT OF
- WAY UNTIL SUCH TIME THAT PERMANENT VEGETATION HAS BEEN ESTABLISHED. 16. DISPOSE OF ALL EXCESS MATERIALS AND TRASH IN ACCORDANCE WITH FEDERAL, STATE, AND LOCAL REQUIREMENTS. PROVIDE WASTE AREAS OR DISPOSAL
- SITES FOR EXCESS MATERIALS NOT DESIRABLE FOR INCORPORATION INTO THE PROJECT. 17. PROPOSED SITE IMPROVEMENTS SHALL NOT INTERFERE WITH OR DELAY ALICE'S ROAD IMPROVEMENTS CONTRACTOR. SITE OWNER'S CONTRACTOR SHALL
- COORDINATE WITH ALICE'S ROAD CONTRACTOR AND CITY STAFF.
- 18. ANY PROPOSED CHANGES TO THE PLAN SET SHALL BE APPROVED IN WRITING BY THE CITY OF CARLISLE DEVELOPMENT SERVICES DEPARTMENT. 19. CONTRACTOR SHALL BE RESPONSIBLE FOR ANY CHANGES MADE DURING CONSTRUCTION THAT HAVE NOT BEEN GRANTED APPROVAL IN WRITING BY THE CITY OF CARLISLE DEVELOPMENT SERVICES DEPARTMENT.
- 20. SURFACED ACCESS TO PAVEMENT WILL BE REQUIRED IF DEVELOPER DOES NOT PROVIDE PAVED ROAD PRIOR TO THIS SITE BEGINNING CONSTRUCTION.

PAVING NOTES:

- 1. THE PAVING/ GRADING CONTRACTOR SHALL BACKFILL THE PAVING SLAB AND FINE GRADE THE RIGHT OF WAY AS SOON AFTER THE PAVING AS POSSIBLE. ALL AREAS SHALL BE SODDED IN ACCORDANCE WITH CITY OF CARLISLE STANDARD SPECIFICATIONS AND THE CURRENT VERSION OF SUDAS.
- 2. SUBGRADE PREPARATION AND PAVEMENTS WILL BE CONSTRUCTED FOLLOWING RECOMMENDATIONS IN THE SOILS REPORT. APPROVED SOILS ENGINEER MUST SIGN OFF ON SUBASE PRIOR TO ANY PAVEMENT BEING PLACED.
- SEE DETAILS FOR ALL PAVEMENT THICKNESS.
- 4. ALL PEDESTRIAN WALKWAYS THAT UNLOAD INTO A VEHICLES TRAVELED PATH MUST HAVE A.D.A. DETECTABLE WARNING PLANEL(S) AS PER A.D.A. REGULATIONS. PANEL TYPE & COLOR SHALL BE PER CITY STANDARD.
- 5. ALL WALKS, PARKING LOTS, HANDICAP PARKING, RAMPS, ETC. SHALL COMPLY WITH ALL A.D.A. AND CITY CODES. HANDICAP PARKING SIGNAGE IS REQUIRED FOR ALL HANDICAP STALLS AND SHALL BE CONSIDERED INCIDENTAL. IN EVENT OF A DISCREPANCY BETWEEN THE PLANS AND THE A.D.A./CITY CODES THE A.D.A./CITY CODES SHALL GOVERN. CONTRACTOR SHALL BE RESPONSIBLE FOR ENSURING A.D.A. CODES ARE MET

- 1. QUANTITY CALLOUTS ON PIPE LENGTHS ARE APPROXIMATE AND SHOULD BE USED FOR REFERENCE ONLY
- 2. THE CONTRACTOR SHALL PROVIDE AS-BUILTS OF ALL UTILITIES, INCLUDING DEPTH AND LOCATION OF ALL SERVICES.
- 3. THE CONTRACTOR SHALL BE RESPONSIBLE FOR COORDINATION AND ALL COSTS ASSOCIATED WITH AS-BUILT TOPO OF DETENTION POND & DETENTION POND STORM SEWER. CONTRACTOR SHALL BE RESPONSIBLE FOR CONTACTING BISHOP ENGINEERING AT 515-276-0467 TO PERFORM SAID AS-BUILT SURVEY. IF DETENTION PONDS HAVE BEEN GRADED INCORRECTLY, CONTRACTOR SHALL BE RESPONSIBLE FOR ALL SUBSEQUENT AS-BUILT TOPO SURVEYS UNTIL ISSUES HAVE BEEN RECTIFIED.
- 4. THE CONTRACTOR SHALL COORDINATE THE ADJUSTMENT OF ANY AND ALL EXISTING AND PROPOSED UTILITIES TO PROPOSED GRADES. EXISTING UTILITIES SHALL BE RAISED OR LOWERED IN ACCORDANCE WITH THE UTILITY OWNER REQUIREMENTS. ANY NECESSARY ADJUSTMENTS SHALL BE CONSIDERED INCIDENTAL TO CONSTRUCTION.
- 5. ACTIVE EXISTING FIELD TILES ENCOUNTERED DURING CONSTRUCTION SHALL BE REPAIRED, REROUTED, OR CONNECTED TO PUBLIC OR PRIVATE STORM SEWER
- 6. ALL PROPOSED RCP STORM SEWER PIPE JOINTS SHALL BE FABRIC WRAPPED AND THE LAST 3 PIPE SECTIONS ON THE APRON SHALL BE TIED WITH RF-14 TYPE II CONNECTORS. ALL APRONS SHALL HAVE A STANDARD FOOTING AND TRASH GUARD.
- 7. WATERMAINS SHALL BE C-900. SIZE OF WATERMAIN AS SHOWN ON PLANS.
- 8. THRUST BLOCKS SHALL BE INSTALLED AS REQUIRED AND SHALL BE CONSIDERED INCIDENTAL TO WATERMAIN CONSTRUCTION
- 9. PROPOSED WATERMAIN SHALL BE PRESSURE TESTED, BACTERIA TESTED AND CHLORINATED. THE FILLING OF THE WATER MAIN SHALL BE DONE BY THE CITY OF
- 10. TRACER WIRE SHALL BE ADDED TO ALL WATER MAIN, AND BROUGHT TO THE SURFACE AT EVERY HYDRANT.
- 11. THE MINIMUM HYDRANT LEAD SHALL BE 3.5 FEET.

PROPOSED CONSTRUCTION

UTILITY CONFLICT NOTES:

- 1. UTILITY CONFLICTS MAY EXIST ACROSS THE SITE WITH NEW UTILITIES, GRADING, PAVING ETC.
- MOST UTILITY CONFLICTS HAVE BEEN CALLED OUT FOR CONTRACTOR CONVENIENCE
- 2. CONTRACTOR IS RESPONSIBLE FOR ALL UTILITY CONFLICTS THAT ARE EITHER CALLED OUT ON THE PLANS OR THAT CAN BE SEEN ON THE PLANS BETWEEN AN EXISTING UTILITY AND

CITY OF CARLISLE NOTES:

1. GENERAL NOTES:

- a. ALL WORK SHALL BE DONE IN ACCORDANCE WITH THE CURRENT VERSION OF THE URBAN STANDARDS SPECIFICATIONS FOR PUBLIC IMPROVEMENTS ON THE DATE OF APPROVAL AND THE CITY OF CARLISLE SUPPLEMENTAL SPECIFICATIONS.
- b. A PRECONSTRUCTION MEETING IS REQUIRED PRIOR TO THE START OF CONSTRUCTION. THE CONTRACTOR SHALL BE RESPONSIBLE TO COORDINATE THIS MEETING WITH THE CITY OF CARLISLE & FOX ENGINEERING
- THE CITY OF CARLISLE MUST BE NOTIFIED BY ALL CONTRACTORS 48 HOURS PRIOR TO COMMENCING WORK. CALL CITY OF CARLISLE (TOMMY THOMPSON 515-505-4299) & FOX ENGINEERING (MITCH HOLTZ 515-233-0000).
- d. ALL PERMITS (IDNR, IDOT, ARMY CORP., ETC.) SHALL BE OBTAINED PRIOR TO THE START OF CONSTRUCTION.
- e. ALL UTILITY CONTRACTORS AND/OR OWNERS SHALL BE RESPONSIBLE TO PROVIDE THE CITY OF CARLISLE WITH "AS-BUILT" DRAWINGS OF ALL IMPROVEMENTS.
- f. ALL SIGNAGE SHALL BE SUPPLIED AND INSTALLED BY THE **CONTRACTOR**
- g. ALL SITE LIGHTING SHALL NOT SPILL ONTO ADJACENT PROPERTIES OR RIGHT-OF-WAYS.

2. SANITARY SEWER NOTES:

- a. THE CONTRACTOR IS REQUIRED TO PLACE A TEMPORARY PLUG IN THE EXISTING DOWNSTREAM SANITARY SEWER MANHOLE PRIOR TO THE START OF CONSTRUCTION. THE PLUG SHALL BE REMOVED FOLLOWING APPROVAL OF CONSTRUCTION BY THE CITY OF CARLISLE.
- b. SANITARY GRAVITY PIPE MATERIAL SHALL BE PVC SDR 26 OR TRUSS (8" TO 15")
- c. SANITARY GRAVITY SERVICE PIPE MATERIAL SHALL BE PVC SDR 23.5 (4" TO 6").
- d. ALL SANITARY SEWER MANHOLES CASTINGS SHALL BE SEALED WITH INTERIOR CHIMNEY SEALS. IN ADDITION, THE MINIMUM SPACER RING SIZE IS 4-INCHES AND THE MAXIMUM NUMBER OF SPACER RINGS SHALL NOT EXCEED 12-INCHES.
- e. ALL SANITARY SEWER MANHOLES SHALL HAVE STEPS.
- ALL SANITARY SEWER MANHOLE CASTINGS LOCATED WITHIN PAVEMENT SHALL BE BOXED OUT.
- MANDREL AND PRESSURE TESTS ARE REQUIRED FOR ALL SANITARY SEWER LINES (8" AND ABOVE) PRIOR TO PAVING. IN ADDITION, ALL SANITARY SEWER LINES SHALL BE TELEVISED. THE SEWER SYSTEM SHALL BE FLUSHED WITH WATER PRIOR TO TELEVISING.

3. WATER MAIN NOTES:

- a. ALL FIRE HYDRANTS SHALL BE MUELLER SUPER CENTURION 250 (3-WAY A-423), 6" MJ SHOE, 2-1/2" HOSE NOZZLE, 4-1/2" STEAMER NOZZLE, NST THREADS, PENTAGON OPERATING NUT, CHAIN ON CAP, OPEN LEFT, AND FACTORY PAINTED RED. THE MINIMUM HYDRANT LEAD SHALL BE 2-FEET.
- b. ALL HYDRANTS WILL IMMEDIATELY BE COVERED WITH A BLACK PLASTIC BAG (OR EQUIVALENT) ONCE THE HYDRANT IS INSTALLED. THE CITY OF CARLISLE WILL NOTIFY THE CONTRACTOR WHEN THE BAGS CAN BE REMOVED.
- c. A TRACER WIRE RECEPTACLE SHALL BE INSTALLED AT EACH HYDRANT (FLUSH MOUNT VALVCO OR APPROVED EQUAL).
- d. TRACER WIRE SHALL BE ADDED TO ALL WATER MAIN.
- e. ALL VALVES SHALL BE RESILIENT WEDGE GATE VALVES. WATER SERVICE SHALL BE 1-INCH MINIMUM TYPE K COPPER.
- g. THE CONTRACTOR IS RESPONSIBLE FOR PRESSURE TESTING, CHLORINATION, AND BACTERIA TEST

4. CONTRACTOR SHALL PROVIDE AS-BUILTS OF FIELD TILES TO BISHOP ENGINEERING.


FIELD TILE NOTES:

- 1. ACTIVE EXISTING FIELD TILES ENCOUNTERED DURING CONSTRUCTION SHALL BE REPAIRED, REROUTED, OR CONNECTED TO PUBLIC OR PRIVATE STORM SEWER TO REMAIN IN SERVICE. CONNECT TO STORM SEWER WITH AN INSERT-A-TEE OR DIRECTLY TO A STORM STRUCTURE.
- 2. IT IS ANTICIPATED THAT THE SITE CONTAINS FIELD TILES, HOWEVER, LIMITED INFORMATION IS AVAILABLE 3. THIS WORK WILL BE ELIGIBLE FOR A CHANGE ORDER IF, AND ONLY IF, PROPOSED SITE STORM SEWER IS NOT WITHIN 50 FEET OF THE FIELD TILE.



SCALE: 1' = 1,000'

LEGEND: ABBREVIATIONS: — SAN — SANITARY SEWER ACRES ASPH ASPHALT — ST — STORM SEWER BOOK CONCRETE CONC — W — WATER LINE DEEDED DISTANCE — G — GAS LINE **EXISTING ENCLOSURE ENCL** — U/E — UNDERGROUND ELECTRIC FINISHED FLOOR — O/E — OVERHEAD ELECTRIC FLOW LINE FRACTIONAL — TELE — TELEPHONE LINE MEASURED DISTANCE MANHOLE — F/O — FIBER OPTIC ORANGE PLASTIC CAP — CATV — CABLE TV PLATTED DISTANCE ⑤ STORM MANHOLE POINT OF BEGINNING POINT OF COMMENCEMENT CURB INTAKE PREVIOUSLY RECORDED AS SURFACE INTAKE PUBLIC UTILITY EASEMENT RIGHT OF WAY FLARED END SECTION RED PLASTIC CAP SANITARY MANHOLE SQUARE FEET SANITARY © CLEANOUT FIRE HYDRANT YPC YELLOW PLASTIC CAP NORTH ♥ SPRINKLER SOUTH EAST IRRIGATION CONTROL VALVE WEST W WATER MANHOLE WATER VALVE ** WATER SHUT OFF **AYARD HYDRANT ©ELECTRIC MANHOLE** ELECTRIC METER **E ELECTRIC RISER**

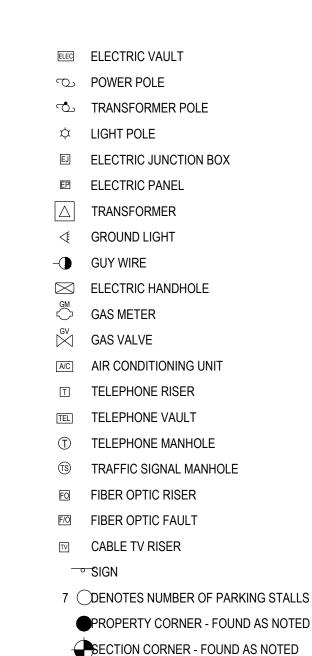

ALL SIDE YARD SETBACKS ARE INTENDED 10 BE USED TO CONVEY STORM WATER FROM THE SUBJECT LOT AND ANY

 $\overline{\mathbf{C}}$ \triangleleft O

REFERENCE NUMBER:

DRAWN BY:

CHECKED BY:

REVISION DATE: 7/27/2020 CITY#1 8/11/2020 CITY#2

PROJECT NUMBER:



THE LOCATION OF THE UTILITIES INDICATED ON THE PLANS HAVE BEEN TAKEN FROM THE FIELD SURVEY, EXISTING PUBLIC RECORDS, AND PLANS PROVIDED BY OTHERS. SURFACE UTILITY LOCATIONS HAVE BEEN FIELD LOCATED BY BISHOP

ENGINEERING, UNLESS OTHERWISE NOTED. ALL UNDERGROUND UTILITY LOCATIONS ARE APPROXIMATE LOCATIONS ONLY. BISHOP ENGINEERING DOES NOT GUARANTEE THE UNDERGROUND LOCATION OF ANY UTILITIES SHOWN. IT SHALL BE THE DUTY OF THE CONTRACTOR TO DETERMINE THE LOCATION AND DEPTH OF ANY UNDERGROUND UTILITIES SHOWN AND IF ANY ADDITIONAL UTILITIES, OTHER THAN THOSE SHOWN ON THE PLANS, MAY BE PRESENT. A REQUEST WAS MADE TO IOWA ONE CALL FOR UTILITY PROVIDERS TO VERIFY, LOCATE, AND MARK THEIR UTILITIES IN THE FIELD.

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STORM WATER POLLUTION PREVENTION PLAN

PROPERTY DESCRIPTION:

OF SECTION 4, TOWNSHIP 77 NORTH, RANGE 23 WEST OF THE 5TH P.M., CARLISLE, WARREN COUNTY, IOWA, IS DESCRIBED AS FOLLOWS: COMMENCING AT THE SOUTHEAST CORNER OF THE NORTHEAST QUARTER OF THE SOUTHEAST QUARTER OF SAID SECTION 4; THENCE N87°24'41"W ASSUMED BEARING ALONG THE SOUTH LINE OF SAID NORTHEAST QUARTER OF THE SOUTHEAST QUARTER OF SECTION 4, A DISTANCE OF 463.53 FEET TO THE POINT OF BEGINNING; THENCE CONTINUING N87°24'41"W ALONG THE SOUTH LINE OF SAID NORTHEAST QUARTER OF THE SOUTHEAST QUARTER OF SECTION 4. A DISTANCE OF 530.87 FEET: THENCE N04°07'45"W, A DISTANCE OF 697.07 FEET; THENCE N06°58'53"E, A DISTANCE OF 326.03 FEET; THENCE N18°28'05"E, A DISTANCE OF 97.64 FEET TO THE SOUTHWEST RIGHT OF WAY LINE OF IOWA HIGHWAY NO. 5; THENCE S49°54'08"E ALONG SAID RIGHT OF WAY LINE, A DISTANCE OF 359.30 FEET; THENCE S51°16'21"E ALONG SAID RIGHT OF WAY LINE, A DISTANCE OF 306.32 FEET; THENCE S00°18'35"W, A DISTANCE OF 712.41 FEET TO THE POINT OF BEGINNING. SAID TRACT OF LAND BEING SUBJECT TO AND TOGETHER WITH ANY AND ALL EASEMENTS AND RESTRICTIONS OF

SAID TRACT OF LAND CONTAINS 11.84 ACRES.

ADDRESS:

1584 HIGHWAY 5 CARLISLE, IA 50047

OWNER:

PASCO STORAGE UNLIMITED LLC 1584 HIGHWAY 5 CARLISLE, IA 50047


BENCHMARK:


SITE CONTROL AND BENCHMARKS:


BASIS OF BEARING OBTAINED FROM GPS OBSERVATIONS DATUM = NAD 83, IOWA SOUTH BENCHMARK DATUM =NAVD88

NORTHING = 546680.98 EASTING = 1639250.10 ELEVATION = 874.00

DESCRIPTION: SET 5/8" IRON PIPE WITH RPC STABILIZED ENTRANCE SHALL BE AT

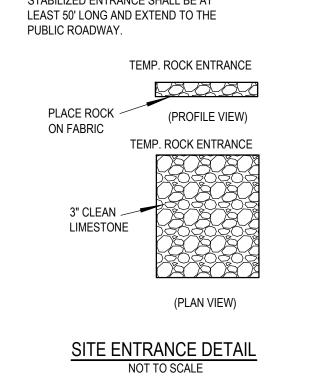


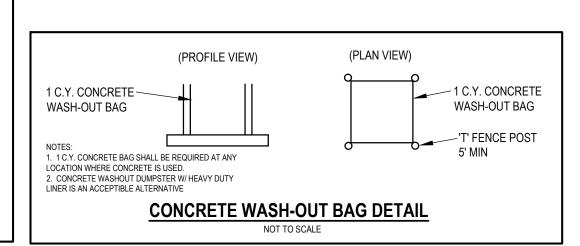

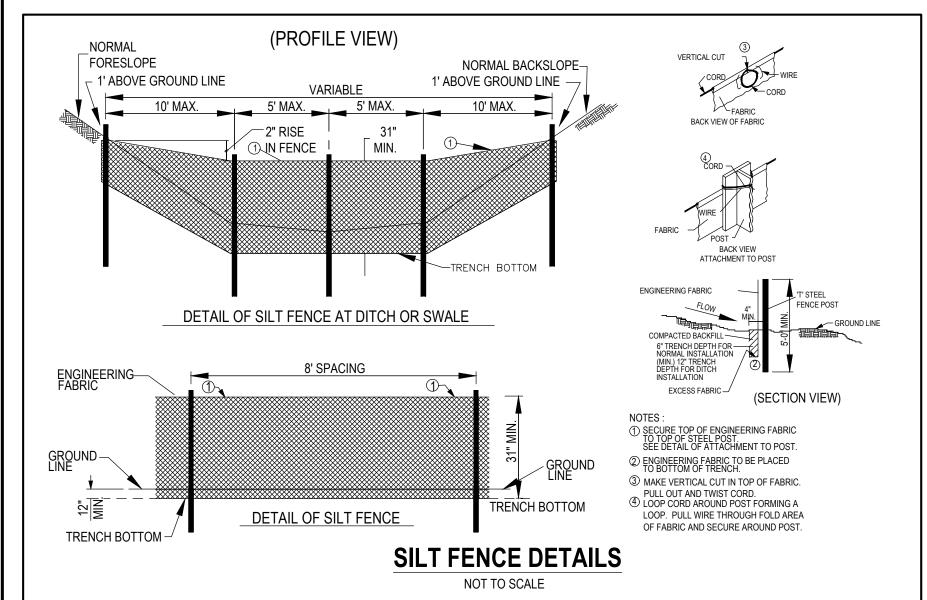



THE LOCATION OF THE UTILITIES INDICATED ON THE PLANS ARE TAKEN FROM EXISTING PUBLIC RECORDS AND ARE APPROXIMATE LOCATIONS. THE EXACT LOCATIONS OF ALL UTILITIES MUST BE ASCERTAINED IN THE FIELD. IT SHALL BE THE DUTY OF THE CONTRACTOR TO DETERMINE WHETHER ANY ADDITIONAL FACILITIES OTHER THAN THOSE SHOWN ON THE PLANS MAY BE PRESENT

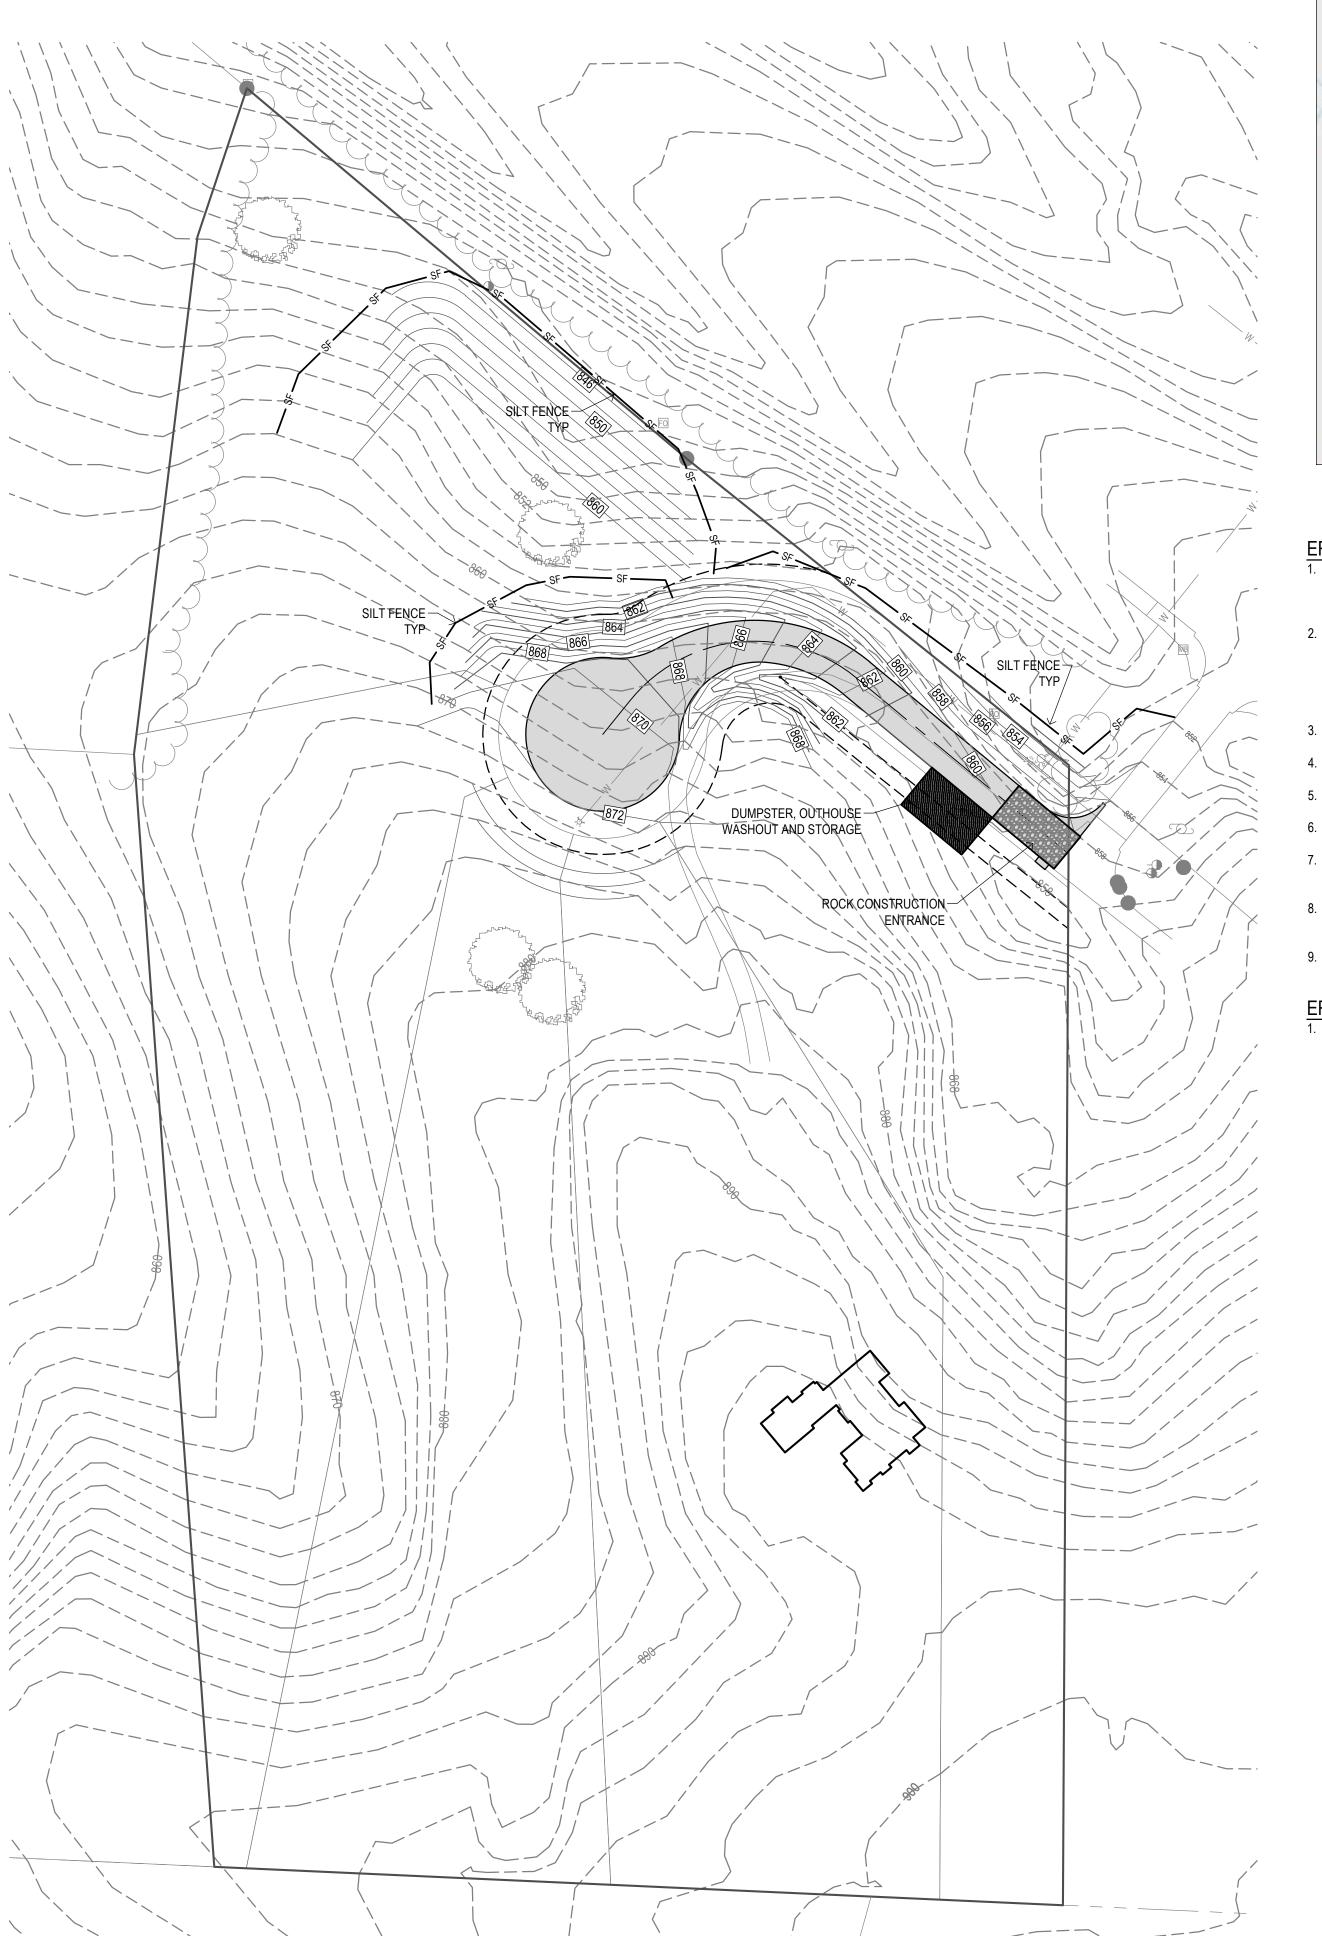



EROSION CONTROL NOTES:

1. SEE SUPPLEMENTAL DETAIL STORM WATER POLLUTION PLAN NARRATIVE FOR ALL EROSION CONTROL MEASURES, ADDITIONAL DETAILS AND NOTE. ADDITIONAL NOTES AND MEASURES IN NARRATIVE SHALL BE CONSIDERED INCIDENTAL AND SHALL BE INCLUDED IN THE ORIGINAL BID.

2. SWPPP PLAN AND NARRATIVE ARE CONSIDERED A LIVING DOCUMENT AND WILL NEED PERIODIC UPDATES AND ADJUSTMENTS AS NECESSARY DEPENDING ON SITE CONDITIONS TO ASSURE COMPLIANCE WITH NPDES GENERAL PERMIT NO. 2. IT IS THE CONTRACTOR'S RESPONSIBILITY TO UPDATE THE SWPPP AND IMPLEMENT ANY AND ALL MEASURES NECESSARY TO COMPLY WITH SAID PERMIT NO. 2.

3. INSTALL PERIMETER SILT FENCE AS SHOWN ON PLANS PRIOR TO

4. INSTALL INTAKE PROTECTION WITH SILT FENCE IMMEDIATELY AFTER STORM —— SF—— SILT FENCE 5. INSTALL FINISHED PAVING INLET PROTECTION IMMEDIATELY AFTER PAVING

IS COMPLETED AROUND INTAKE. 6. OTHER EROSION CONTROL TYPES MAY NOT BE SUBSTITUTED FOR SILT

7. CONTRACTOR SHALL BE RESPONSIBLE FOR SUPPLYING A CONCRETE WASHOUT IN ACCORDANCE WITH NPDES GENERAL PERMIT NO. 2 DURING ALL GAS LINE

8. CONTRACTOR SHALL BE RESPONSIBLE FOR SUPPLYING TEMPORARY RESTROOM FACILITIES. SANITARY WASTE SHALL BE DISPOSED OF PER ALL FEDERAL, STATE AND LOCAL REGULATIONS.

EROSION CONTROL REMOVAL NOTES: . AFTER FINAL STABILIZATION HAS OCCURED, AS DEFINED IN NPDES GENERAL PERMIT NO. 2, CONTRACTOR SHALL BE RESPONSIBLE FOR THE REMOVAL OF ALL TEMPORARY EROSION CONTROL DEVICES INCLUDING, BUT NOT LIMITED TO: SILT FENCE, INLET PROTECTION, AND TEMPORARY STANDPIPES

— −120− − EXISTING CONTOUR

— O/E — OVERHEAD ELECTRIC

— TELE — TELEPHONE LINE

— F/O — FIBER OPTIC

—— ST—— STORM SEWER — W — WATER LINE

—U/E—— UNDERGROUND ELECTRIC

9. CONTRACTOR SHALL BE RESPONSIBLE FOR ENSURING ALL TOPSOIL REQUIREMENTS OF NPDES GENERAL PERMIT NO. 2 ARE MET.

> — CATV— CABLE TV STORM MANHOLE

> > **CURB INTAKE** SURFACE INTAKE

FLARED END SECTION

S SANITARY MANHOLE © CLEANOUT FIRE HYDRANT

SPRINKLER irrigation control valve W WATER MANHOLE

W WELL

WATER VALVE ₩ WATER SHUT OFF YARD HYDRANT

© ELECTRIC MANHOLE ELECTRIC METER

E ELECTRIC RISER ELECTRIC VAULT POWER POLE

TRANSFORMER POLE

ELECTRIC JUNCTION BOX ELECTRIC PANEL

☐ TRANSFORMER ─ GUY WIRE

ELECTRIC HANDHOLE GAS METER

GAS VALVE AIR CONDITIONING UNIT

TELEPHONE VAULT

TELEPHONE MANHOLE TRAFFIC SIGNAL MANHOLE FIBER OPTIC RISER

F/O FIBER OPTIC FAULT

→ SIGN **GRAPHIC SCALE**

SHEET NUMBER:

IOWA RLISL

REFERENCE NUMBER:

CA

DRAWN BY:

CHECKED BY: REVISION DATE: 7/27/2020 CITY#1

PROJECT NUMBER:

Aspen Business Park 414 South 17th Street, Suite 107 Ames, Iowa 50010

August 13, 2020

Brad Kuehl

Bishop Engineering Company, Inc. 3501 104th Street Des Moines, IA 50322

Pasco Point - Final Plat Review

Carlisle, Iowa FOX Ref No: 8666-20C.230

Thank you for submitting your project for review. The City is committed to assisting you with the completion of this project. FOX Engineering and the City Staff has completed the second review for the Pasco Point Final Plat, with date stamp of August 11, 2020 and as submitted to FOX Engineering via email on August 11, 2020 and offers the following comments:

1. Approval of this Final Plat is subject to review/approval of the Preliminary Plat and Construction Drawings for Pasco Point, as they are being submitted for approval concurrently.

2. Plat comments:

- a. Per 180.09(2)(E) Final Plat Requirements, the proposed Pasco Point roadway centerline needs to have a reference dimension from a lot corner. In addition, please provide a dimension from the centerline to the ROW.
- b. There is a plat note that indicates references to a Plat of Survey, dated 6-18-2018 and recorded 6-19-2018. The Plat of Survey shows monuments at all the outer corners of the area currently being platted. Please reconcile the symbols on the final plat as there should be existing monumentation at corners where this plat shows new monuments being set. Bear in mind that found monuments control over discrepancies in distance.
- c. The City will provide addresses to each lot. These addresses shall be shown on the final plat.
- d. You may consider increasing the right of way width in lieu of providing the 10-ft roadway easement. There is no difference and would save the necessary step of providing a roadway easement document to file with the plat.
- e. Please show a 30-ft setback along Highway 5 for Lot 5.
- 3. 180.09.03.A, please provide a warranty deed to the City properly executed for all street intended as public streets and any other property intended for public use.
- 4. 180.09.03.B, please submit any covenants or restrictions to be imposed upon the plat. These should be the Final Development Plan Documents that have already been approved that defines the by-laws of the common areas that are NOT dedicated to the City. These documents need to be recorded in the office of the County Recorder.
- 5. 180.09.03.D, please provide a certificate by the Owner that the subdivision is free of consent and is in accordance with the desires of the owner.
- 6. Please provide an Easement Dedication document which states the restrictions on the easements (PUE's and Roadway Easements) as shown on the Final Plat.

- 7. As-built record drawings shall be submitted within 30 days after the completion of construction. The Engineer shall field verify all structures (valves, hydrants) and flowlines.
- 8. Please provide maintenance bonds for all pavement and utilities to be dedicated to the city of Carlisle. The bond period shall begin once all infrastructure is installed and accepted. City Engineer shall review the bond amounts prior to submission of for bond documents. Maintenance Bonds for this plat are as follows (180.03, 15):
 - a. Streets 4-yr Maintenance Bond
 - b. Water Mains 2-yr Maintenance Bond
- 9. Please provide performance bonds for all incomplete construction. Please provide an opinion of cost for City review prior to submittal of the performance bond.

FINAL PLAT SCHEDULE:

PLANNING & ZONING: August 17, 2020 at 7:00 at the Carlisle City Hall

COUNCIL MEETING: August 24, 2020 at 6:30 at the Carlisle City Hall

If you have any questions or concerns, please contact Mitch Holtz at 515-231-6005. The City reserves the right to modify or add to these comments.

FOX ENGINEERING ASSOCIATES, INC.

Mitch Holtz, P.E.

Copy to: Deven Markley, City Administrator, Carlisle



PASCO POINT FINAL PLAT

INDEX LEGEND

NE 1/4 OF THE SE 1/4 OF SECTION 4-77-23

OWNER:

PASCO STORAGE UNLIMITED INC PO BOX 66027

WEST DES MOINES, IA 50265 PREPARED FOR:

PASCO STORAGE UNLIMITED INC PO BOX 66027

WEST DES MOINES, IA 50265

PREPARED BY: LARRY HYLER PLS

BISHOP ENGINEERING 3501 104TH ST

URBANDALE, IA 50322

PROPERTY DESCRIPTION:

AN IRREGULAR SHAPED PORTION OF THE NORTHEAST QUARTER OF THE SOUTHEAST QUARTER OF SECTION 4, TOWNSHIP 77 NORTH, RANGE 23 WEST OF THE 5TH P.M., CARLISLE, WARREN COUNTY, IOWA, IS DESCRIBED AS FOLLOWS: COMMENCING AT THE SOUTHEAST CORNER OF THE NORTHEAST QUARTER OF THE SOUTHEAST QUARTER OF SAID SECTION 4; THENCE N87°24'41"W ASSUMED BEARING ALONG THE SOUTH LINE OF SAID NORTHEAST QUARTER OF THE SOUTHEAST QUARTER OF SECTION 4, A DISTANCE OF 463.53 FEET TO THE POINT OF BEGINNING; THENCE CONTINUING N87°24'41"W ALONG THE SOUTH LINE OF SAID NORTHEAST QUARTER OF THE SOUTHEAST QUARTER OF SECTION 4, A DISTANCE OF 530.87 FEET; THENCE N04°07'45"W, A DISTANCE OF 697.07 FEET; THENCE N06°58'53"E, A DISTANCE OF 326.03 FEET; THENCE N18°28'05"E, A DISTANCE OF 97.64 FEET TO THE SOUTHWEST RIGHT OF WAY LINE OF IOWA HIGHWAY NO. 5; THENCE S49°54'08"E ALONG SAID RIGHT OF WAY LINE, A DISTANCE OF 359.30 FEET; THENCE S51°16'21"E ALONG SAID RIGHT OF WAY LINE, A DISTANCE OF 306.32 FEET; THENCE S00°18'35"W, A DISTANCE OF 712.41 FEET TO THE POINT OF BEGINNING.

SAID TRACT OF LAND BEING SUBJECT TO AND TOGETHER WITH ANY AND ALL EASEMENTS AND RESTRICTIONS OF RECORD.

SAID TRACT OF LAND CONTAINS 11.84 ACRES.

R1: ONE AND TWO FAMILY RESIDENTIAL DISTRICT

BULK REGULATIONS:

35 FEET

7 FOOT MIN ONE SIDE, 15 FEET MIN TOTAL

MAX. HEIGHT 35 FEET

SURVEY NOTES:

THIS PLAT HAS AN ERROR OR CLOSURE OF LESS THAN 1.0 FEET IN 10,000.0 FEET. EACH LOT WITHIN THIS PLAT HAS AN ERROR OF CLOSURE OF LESS THAN 1.0 FEET IN 5,000.0 FEET.

ALL CORNERS HAVE BEEN PLACED WITH A 3/4 INCH IRON PIPE UNLESS NOTED OTHERWISE. ALL CORNERS PLACED HAVE A YELLOW PLASTIC IDENTIFICATION CAP NO. 14775.

ALL BEARINGS ARE BASED ON AN ASSUMED MERIDIAN FOR COMPUTATION PURPOSES

LOT 'A' IS A STREET LOT AND WILL BE DEEDED TO THE CITY OF CARLISLE.

LEGEND:

PROPERTY CORNER - FOUND AS NOTED

PROPERTY CORNER- PLACED 3/4" IRON PIPE WITH YELLOW PLASTIC CAP ID #14775

SECTION CORNER - FOUND AS NOTED

ADDRESS

ABBREVIATIONS:

PUBLIC UTILITY EASEMENT

TYP TYPICAL NORTH


SOUTH


EAST

WEST YELLOW PLASTIC CAP

POB POINT OF BEGINNING POC POINT OF COMMENCEMENT

MINIMUM PROTECTION ELEVATION SQUARE FOOTAGE

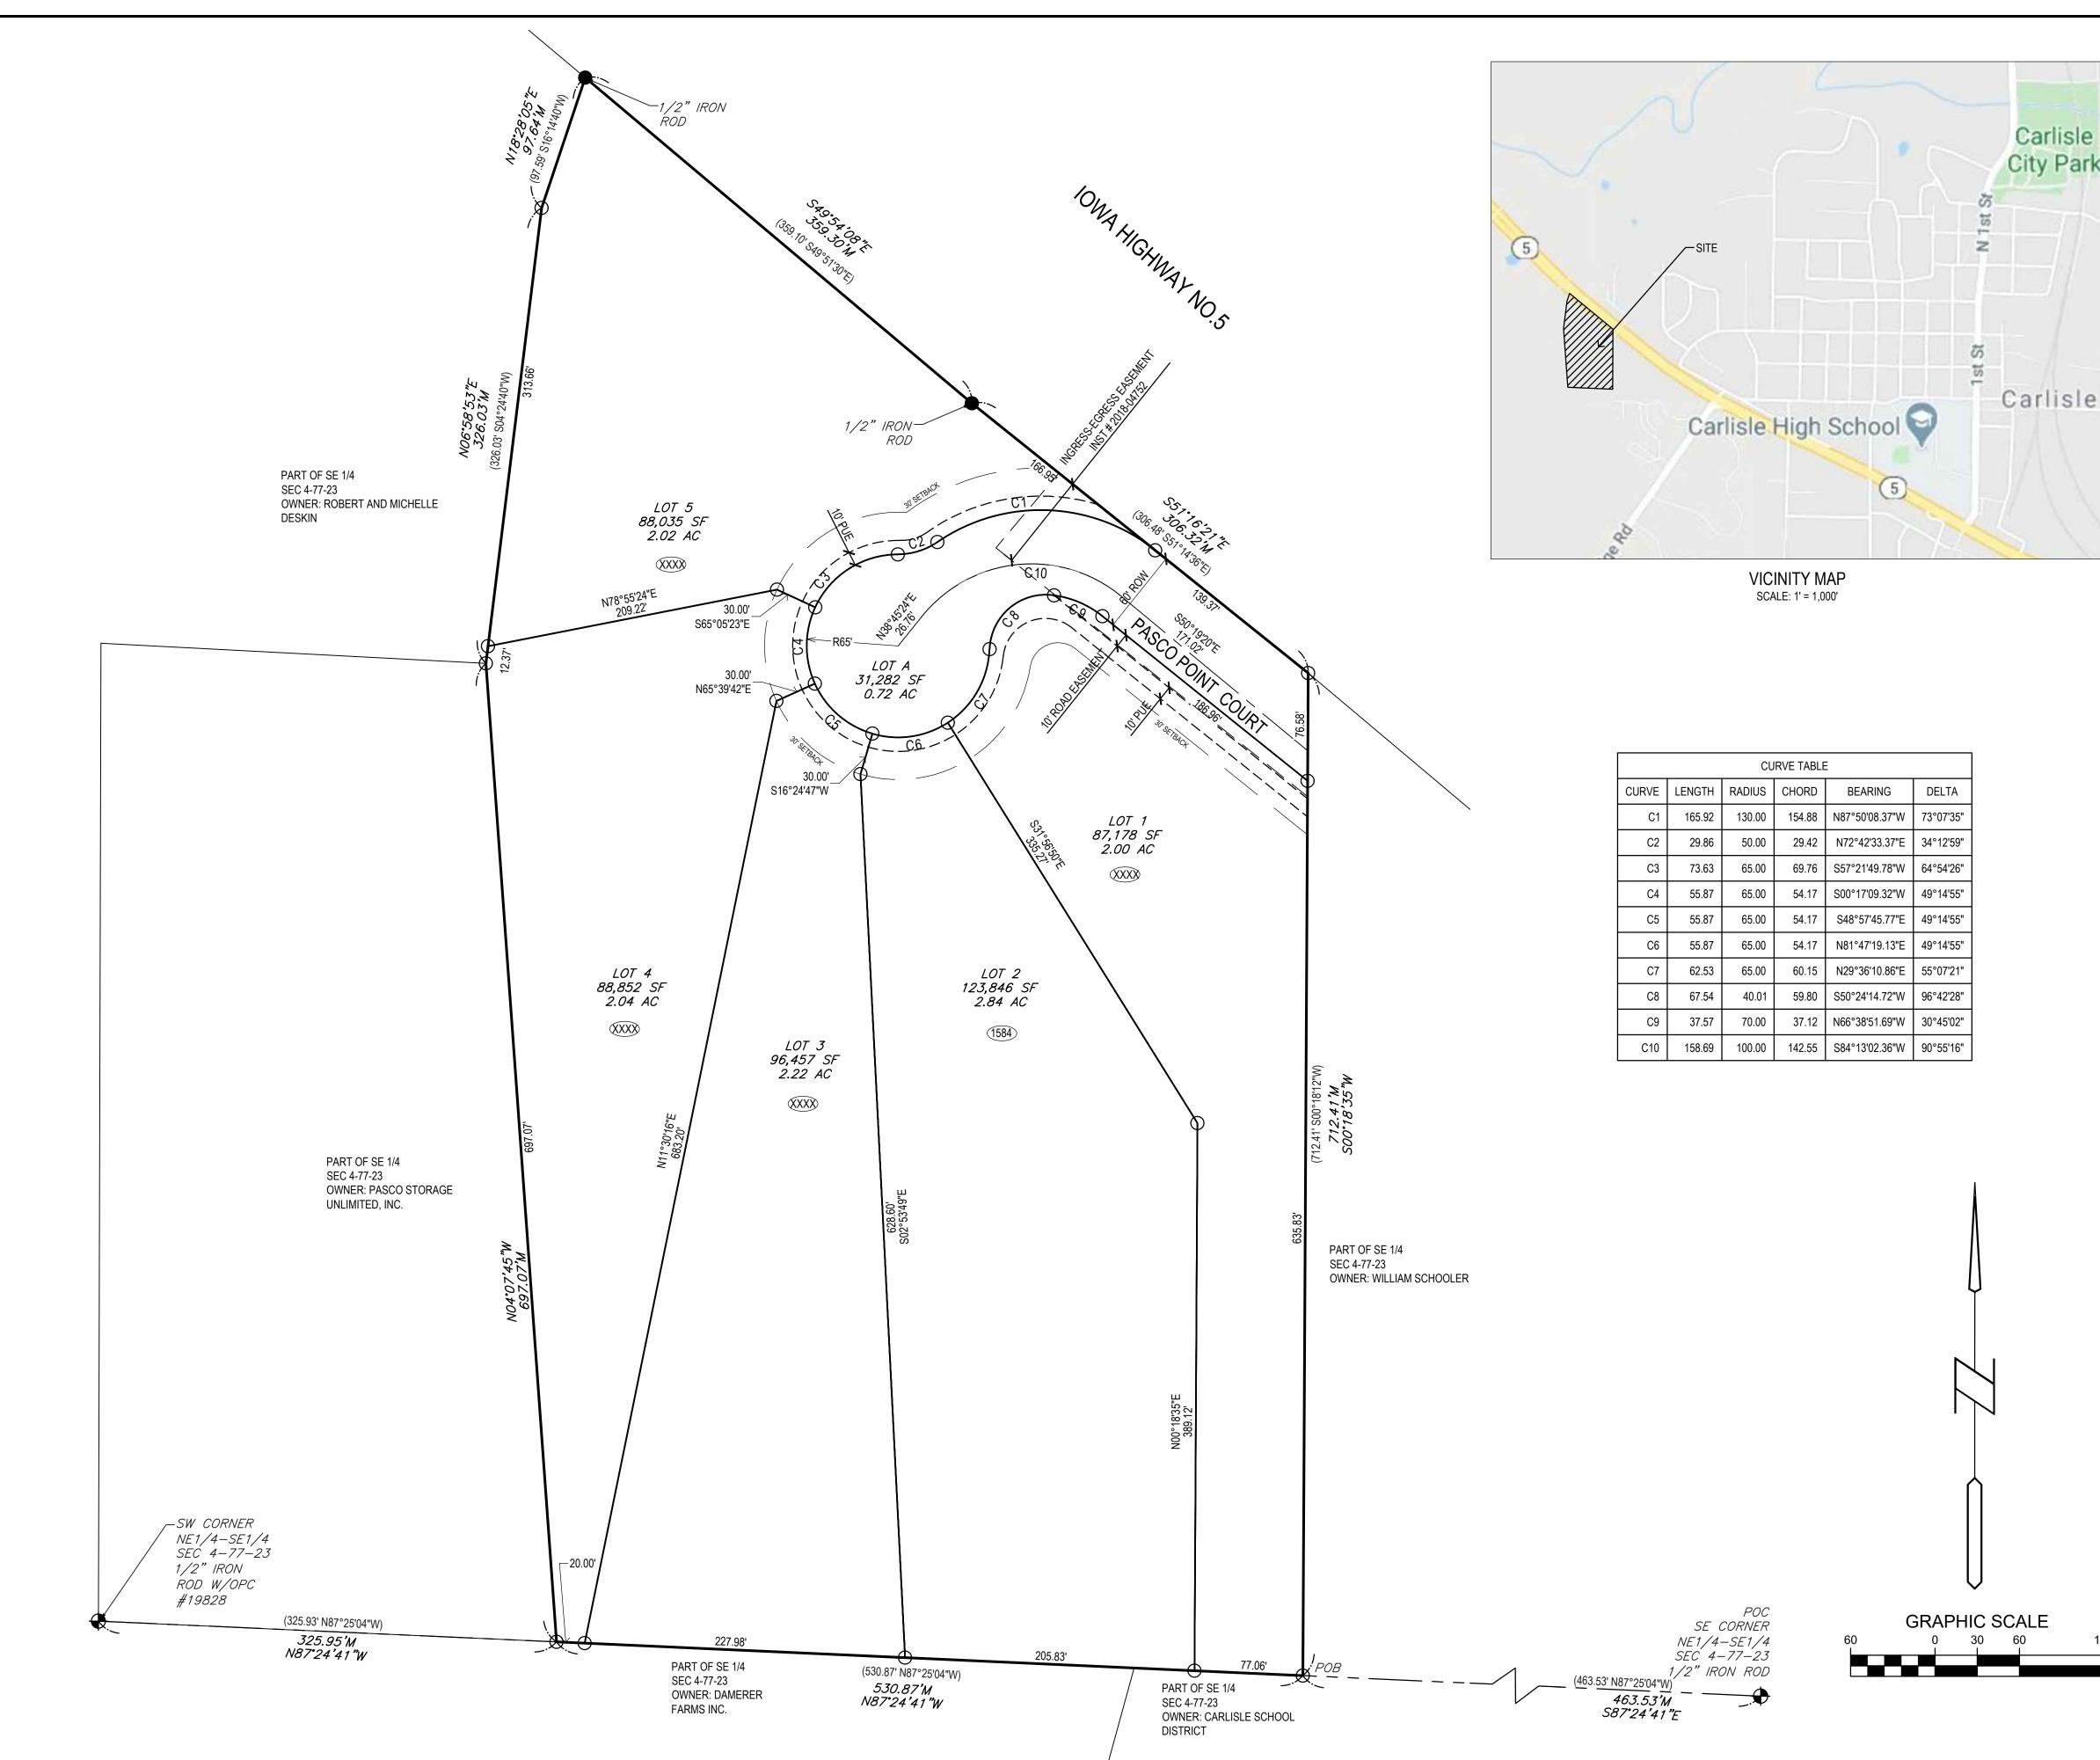

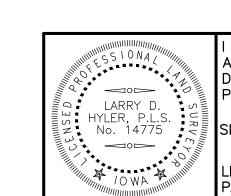

HEREBY CERTIFY THAT THIS LAND SURVEYING DOCUMENT WAS PREPARED AND THE RELATED SURVEY WORK WAS PERFORMED BY ME OR UNDER MY DIRECT PERSONAL SUPERVISION AND THAT I AM A DULY LICENSED PROFESSIONAL LAND SURVEYOR UNDER THE LAWS OF THE STATE OF IOWA.

SIGNED: LARRY D. HYLER, P.L.S. 14775 LICENSE RENEWAL DATE: DEC. 31, 2020 PAGES OR SHEETS COVERED BY THIS SEAL: 1 OF 1 PROJECT NUMBER:

SHEET NUMBER: 1 OF

IOWA

CARLISL

REFERENCE NUMBER:

DRAWN BY:

CHECKED BY:


REVISION DATE:

CEJ

LDH

120

Beacon Warren County, IA

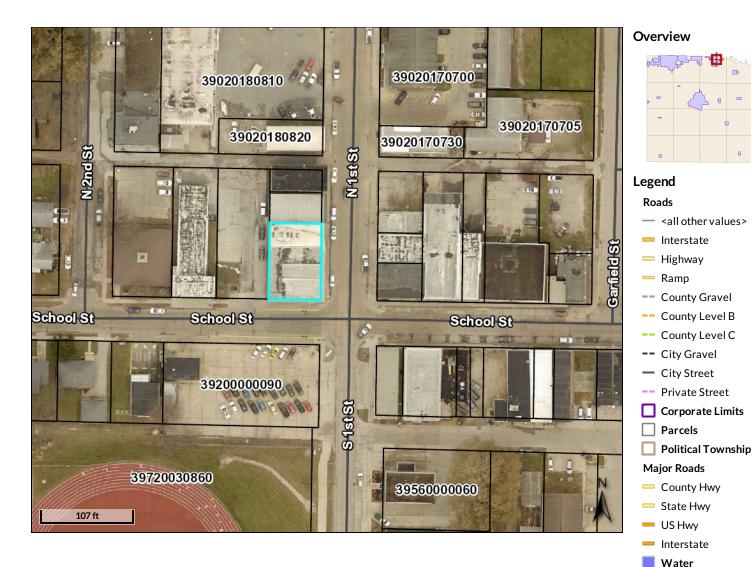

 Parcel ID
 39020180860
 Alternate ID
 n/a
 Owner Address
 CITY OF CARLISLE, IOWA

 Sec/Twp/Rng
 n/a
 Class
 C
 195 N 1ST ST

 Property Address
 100 N 1ST ST
 Acreage
 n/a
 CARLISLE IA 50047

District 39100

CARLISLE

Brief Tax Description 3-77-23 CARLISLE OTP S 85.5' LOT 8 BLK R

(Note: Not to be used on legal documents)

Disclaimer:

The maps included in this website do not represent a survey and are compiled from official records, including plats, surveys, recorded deeds, and contracts, and only contain information required for government purposes. No warranties, expressed or implied, are provided for the data herein, its use or its interpretation. Warren County assumes no responsibility for use or interpretation of the data. Any person that relies on any information obtained from this site does so at his or her own risk. All critical information should be independently verified.

The 2,000 Foot Buffers layer is for law enforcement guidance only, and is based on the best information available at the time it was prepared. This layer should not be considered to be a complete and accurate representation of the locations of every school or child care facility, and will be changed as new information is available. The registered offender is responsible for ensuring that proposed residence is in compliance with the law, and may not rely solely on this layer. The registered offender should seek legal advice from a licensed attorney if needed.

Date created: 8/13/2020 Last Data Uploaded: 8/12/2020 9:27:07 PM



Aspen Business Park 414 South 17th Street, Suite 107 Ames, Iowa 50010

August 13, 2020

City of Carlisle

Attn: Deven Markley 195 N. First Street Carlisle, Iowa 50047

Carlisle City Hall – Site Plan

100 N First Street, Carlisle, IA 50047 FOX P.N. 8666-20D.240

FOX Engineering has completed the second review for the Carlisle City Hall Remodel Site Plan as sent via email to FOX Engineering on August 11, 2020, and offers the following comments:

General Site Plan Note:

1. Patch in School Street is shown as HMA. FOX recommends providing a PCC patch in this area to match and tie-into existing PCC street paving. Please discuss with Public Works.

Storm Water Management:

2. No detention is required for this site plan (no impervious surfaces are added).

Landscaping:

3. None Required.

SITE PLAN SUBMITTAL SCHEDULE:

PLANNING & ZONING: August 17, 2020 at 7:00 at the Carlisle City Hall

COUNCIL MEETING: August 24, 2020 at 6:30 at the Carlisle City Hall

If you have any questions or concerns, please contact Mitch Holtz. We reserve the right to modify and/or add to these comments.


Sincerely,

FOX ENGINEERING ASSOCIATES, INC.

Mitch Holtz, P.E.

Copy to: Dana Pedersen, Ethos

Heather Hoffman, Ethos

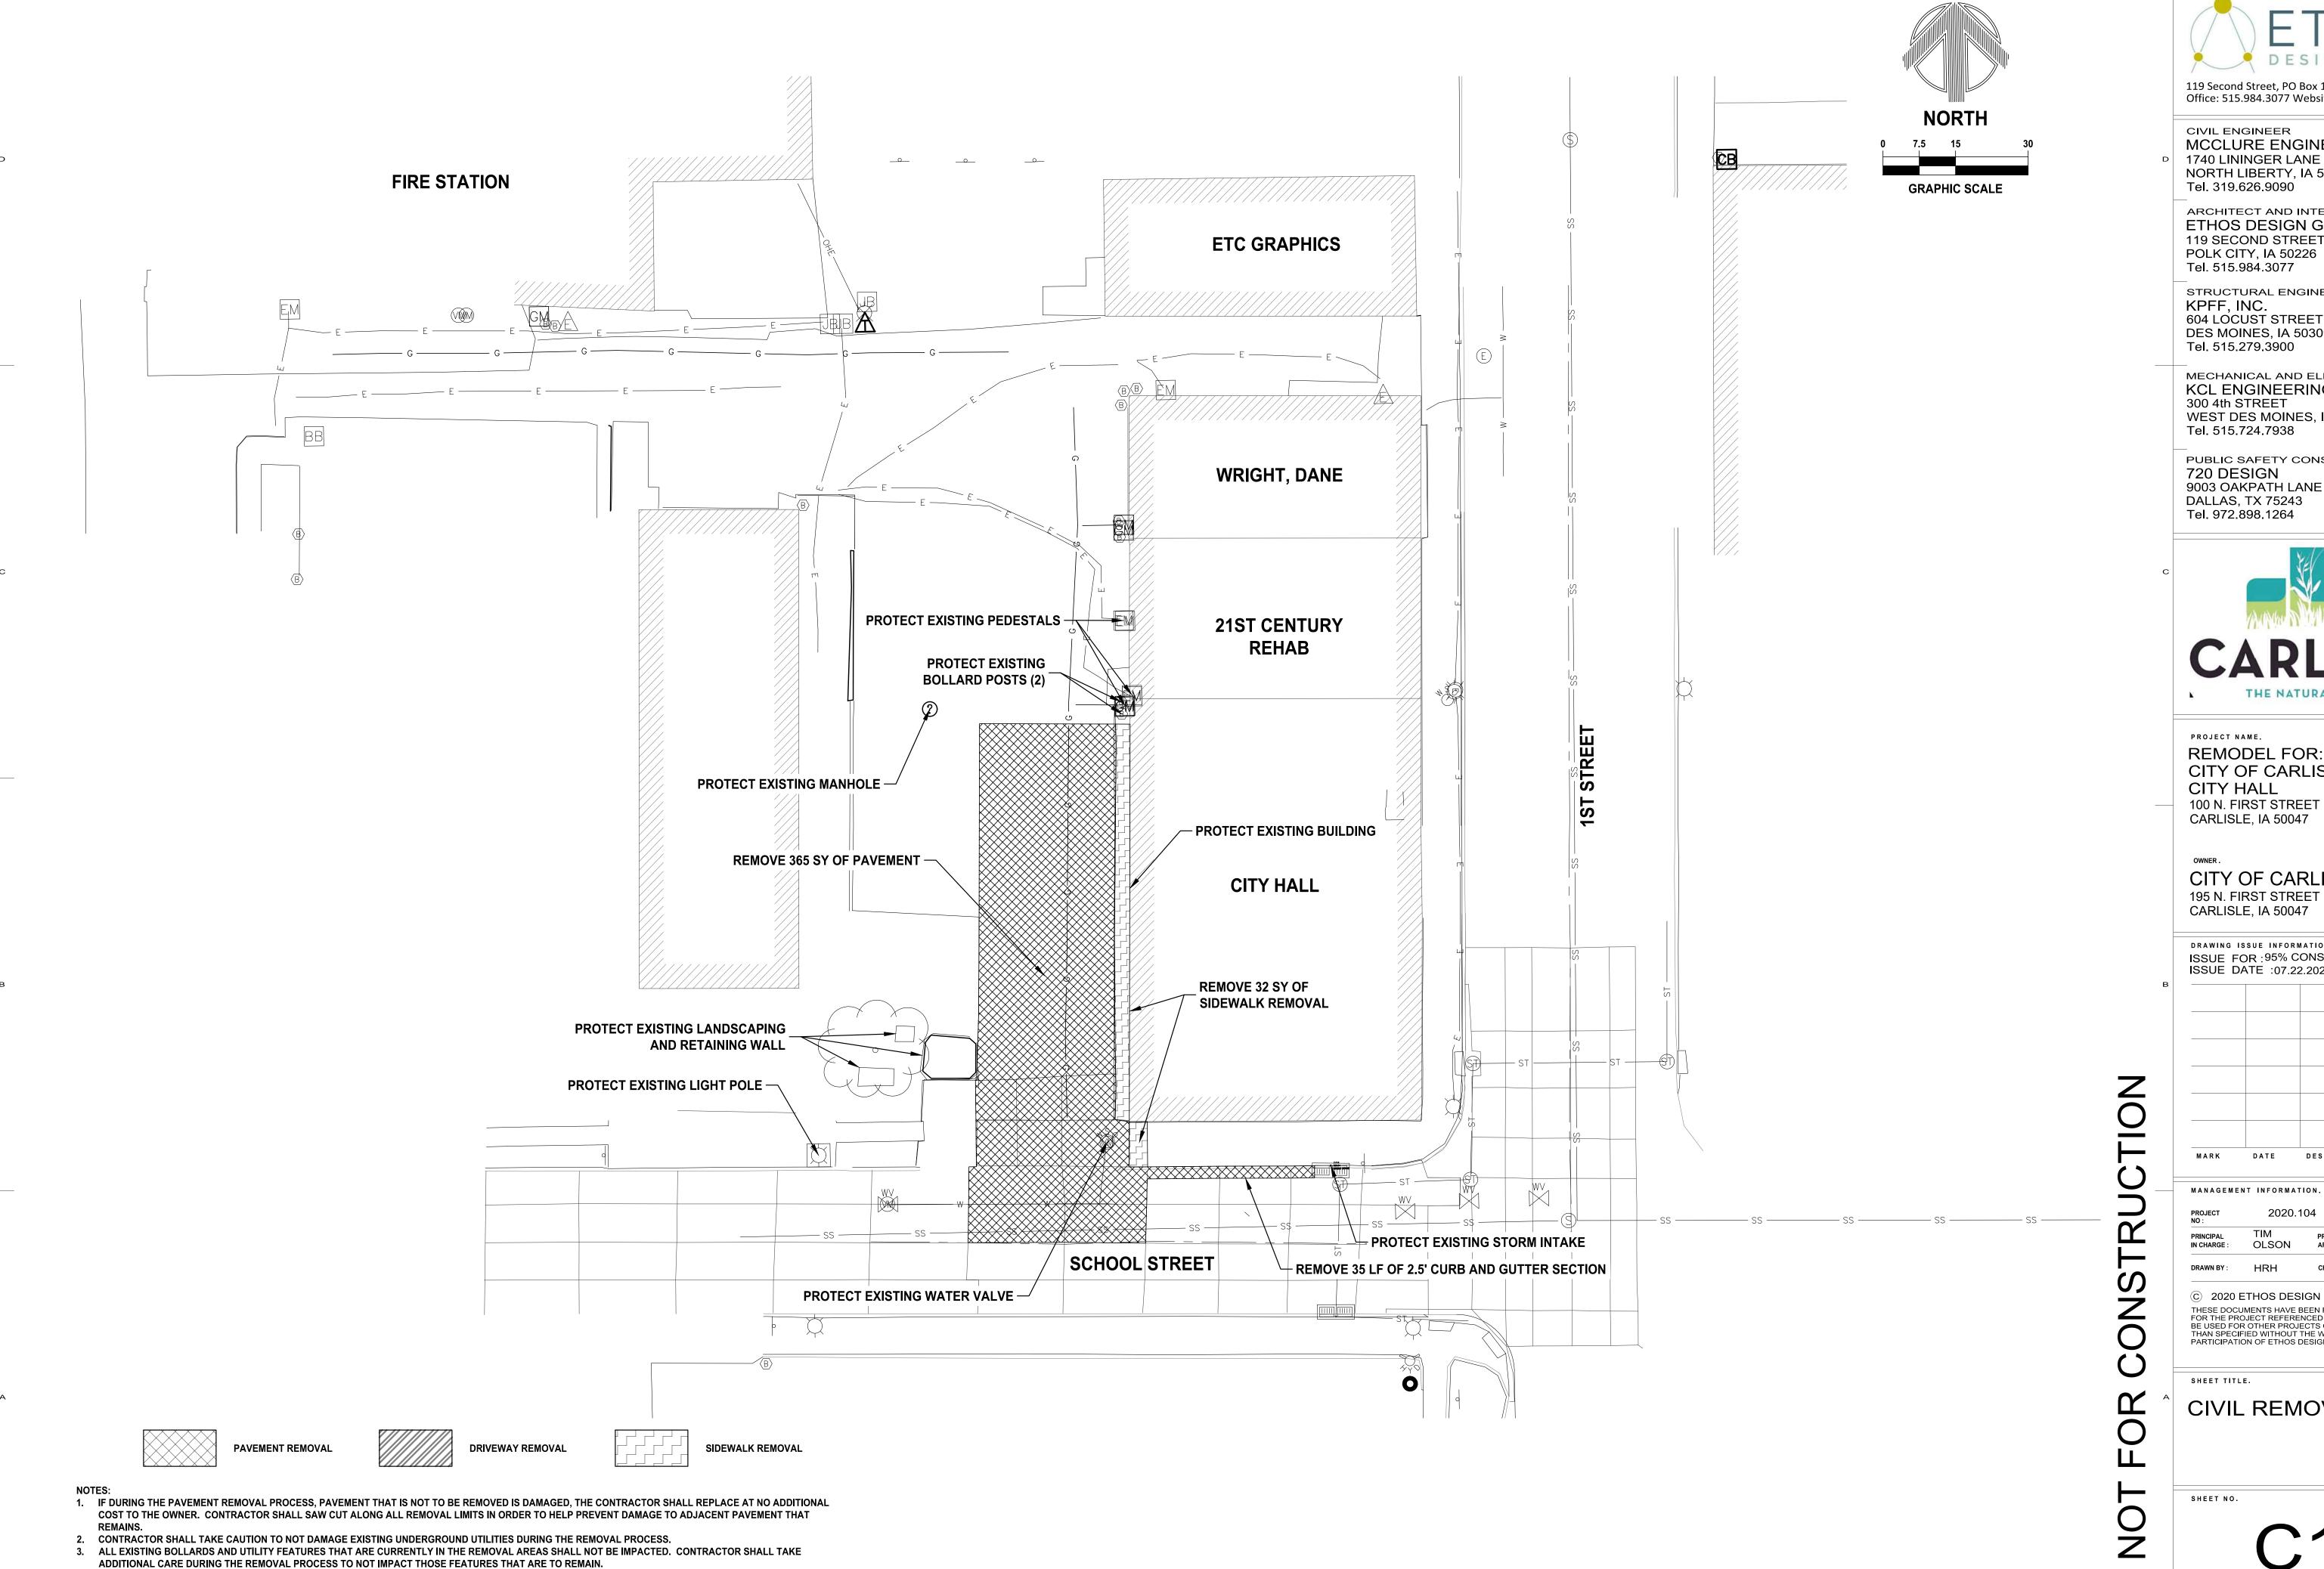



119 Second Street, PO Box 169 Polk City, IA 50226 Office: 515.984.3077 Website: www.ethos.archi

CIVIL ENGINEER MCCLURE ENGINEERING CO. 1740 LININGER LANE NORTH LIBERTY, IA 52317 Tel. 319.626.9090

ARCHITECT AND INTERIOR DESIGNER ETHOS DESIGN GROUP, INC. 119 SECOND STREET, PO BOX 169 POLK CITY, IA 50226 Tel. 515.984.3077

STRUCTURAL ENGINEER KPFF, INC. 604 LOCUST STREET, SUITE 202 DES MOINES, IA 50309 Tel. 515.279.3900

MECHANICAL AND ELECTRICAL ENGINEER KCL ENGINEERING 300 4th STREET WEST DES MOINES, IA 50265


PUBLIC SAFETY CONSULTANT 720 DESIGN 9003 OAKPATH LANE DALLAS, TX 75243 Tel. 972.898.1264



PROJECT NAME. REMODEL FOR: CITY OF CARLISLE CITY HALL 100 N. FIRST STREET CARLISLE, IA 50047

CITY OF CARLISLE 195 N. FIRST STREET CARLISLE, IA 50047

DRAWING ISSUE INFORMATION. ISSUE FOR: 95% CONSTRUCTION DOCS ISSUE DATE :07.22.2020

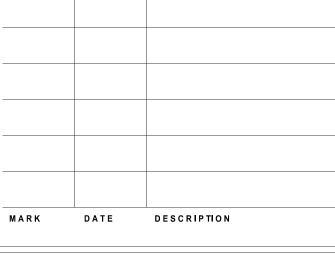


2020.104 DANA OLSON PEDERSEN ARCHITECT:

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CHECKED BY: DLP

CIVIL REMOVAL PLAN

SHEET NO.

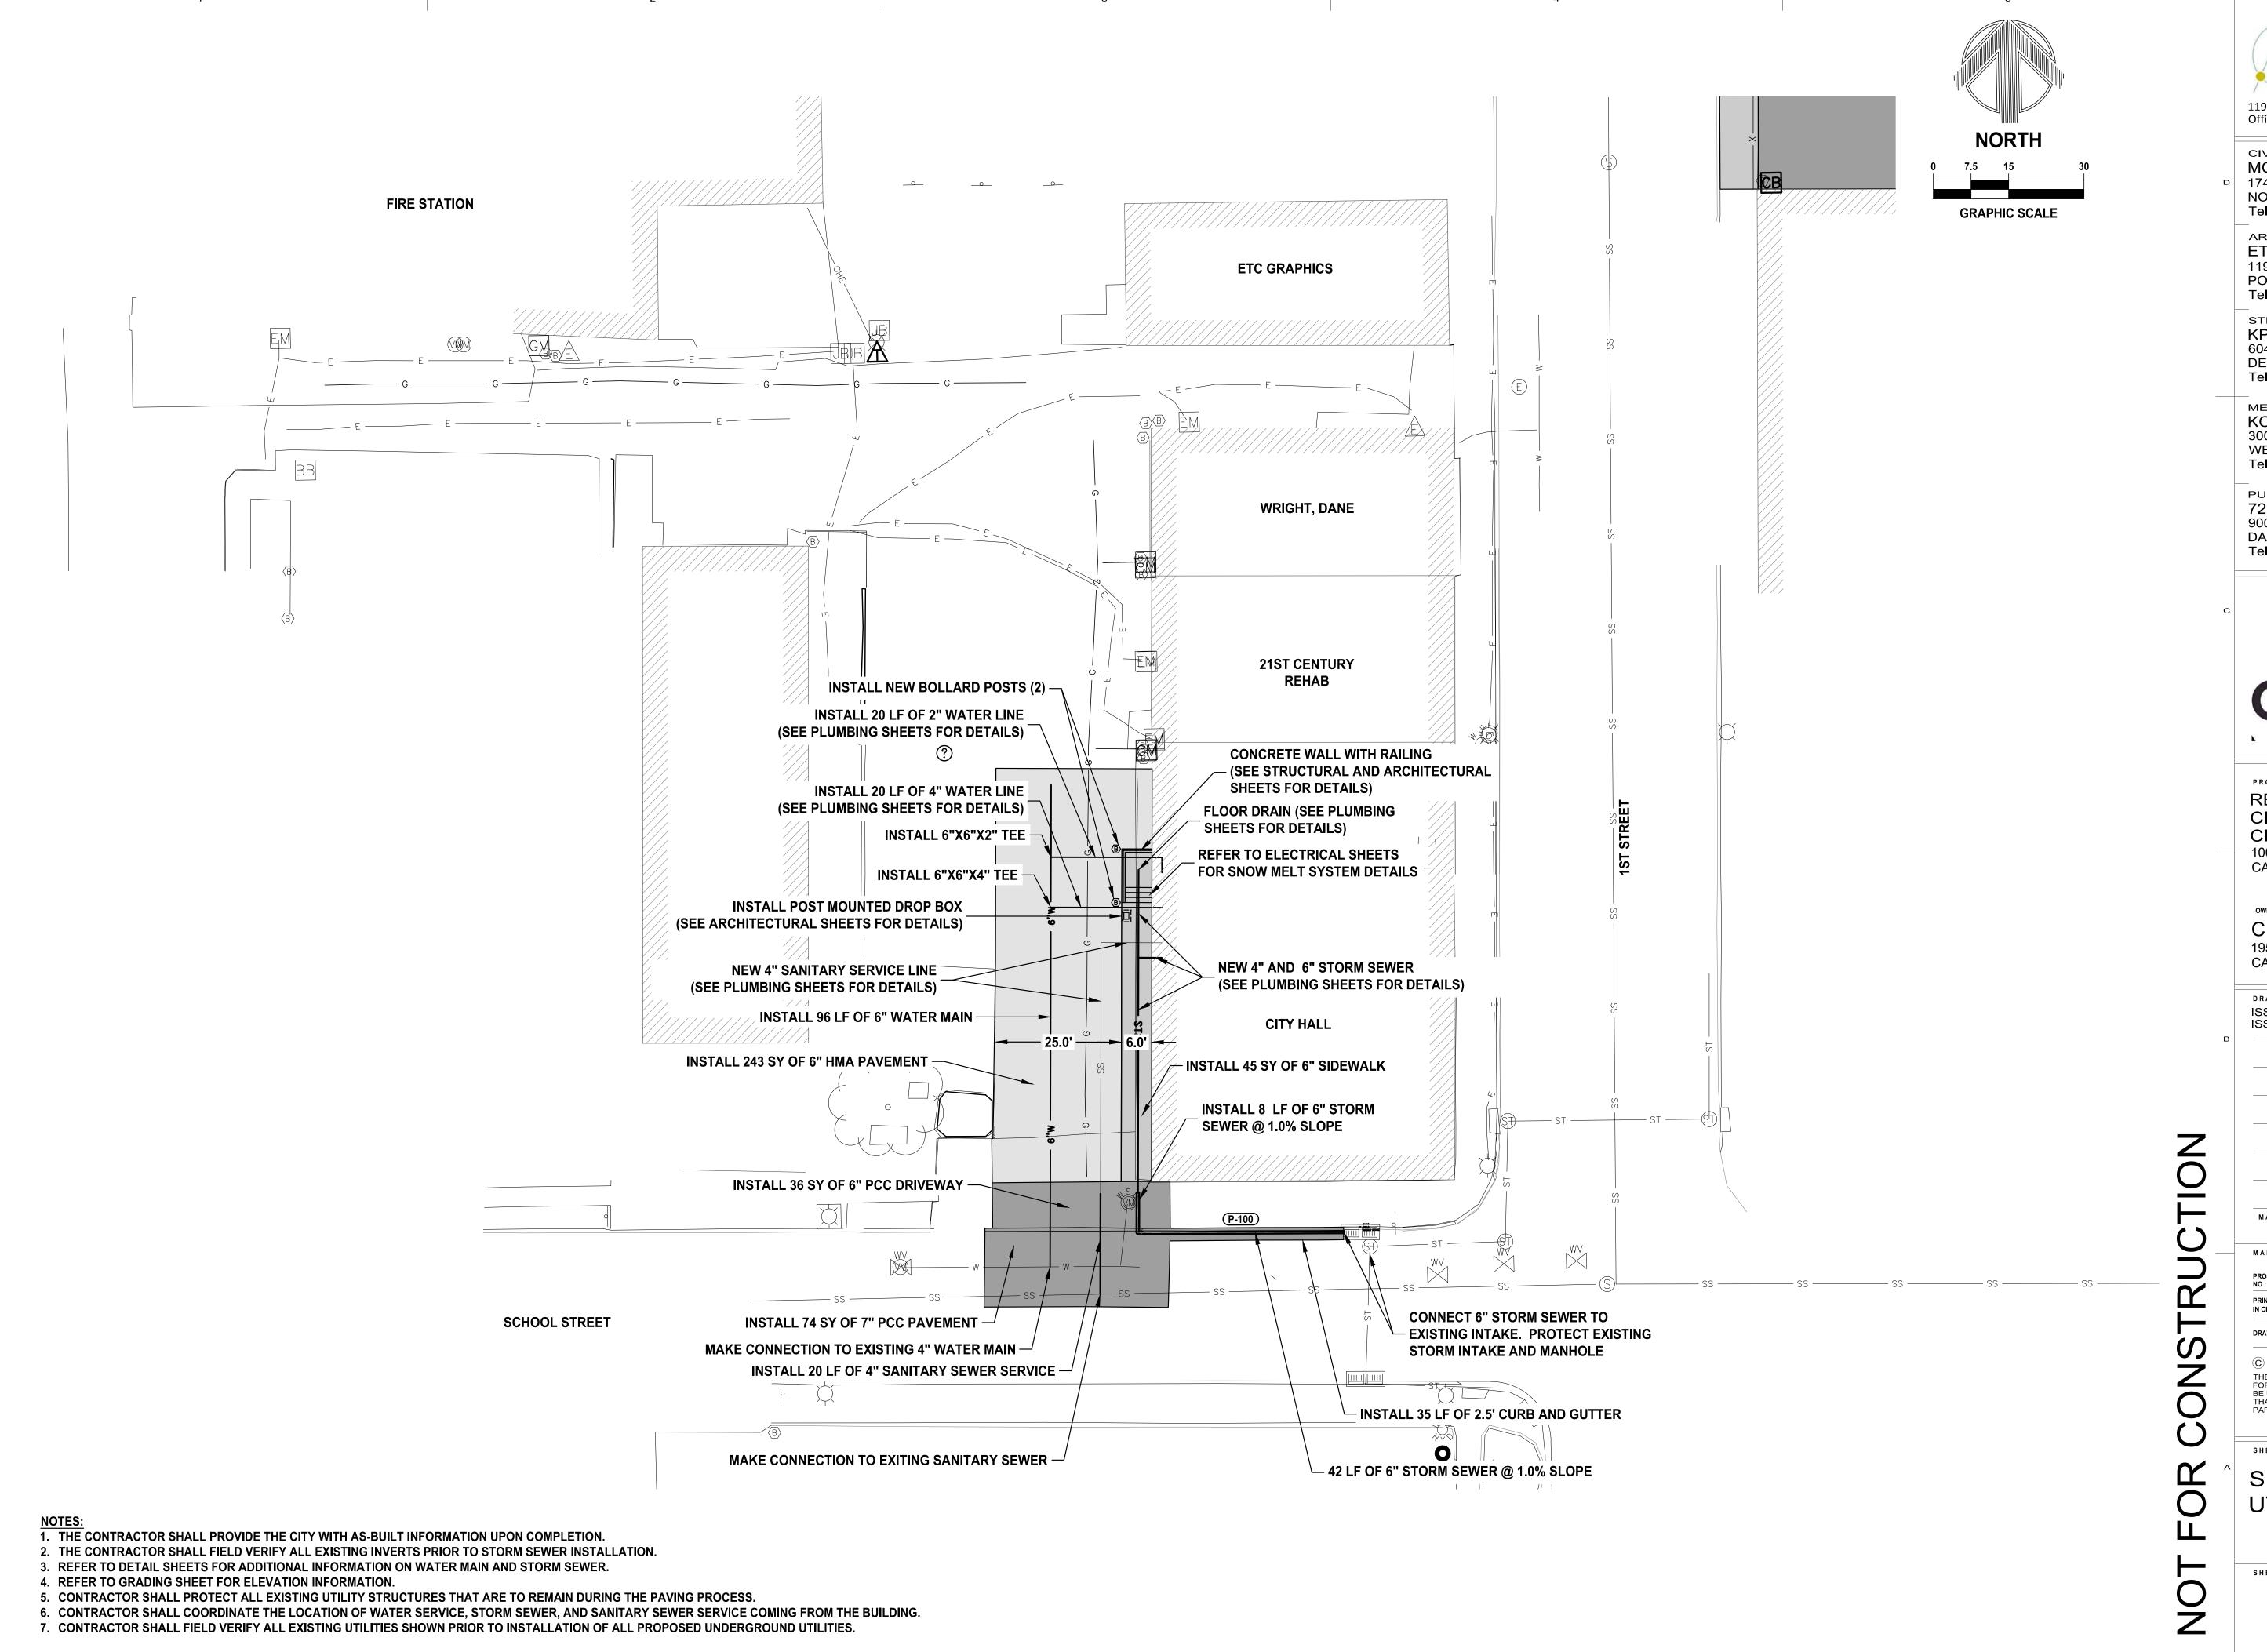

ETHOS DESIGN GROUP

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DES MOINES, IA 50309
Tel. 515,279,3900

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KCL ENGINEERING
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Tel. 515.724.7938

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REMODEL FOR: CITY OF CARLISLE CITY HALL 100 N. FIRST STREET CARLISLE, IA 50047

OWNER.

CITY OF CARLISLE


195 N. FIRST STREET

CARLISLE, IA 50047

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ISSUE FOR: 95% CONSTRUCTION DOCS

ISSUE DATE: 07.22.2020

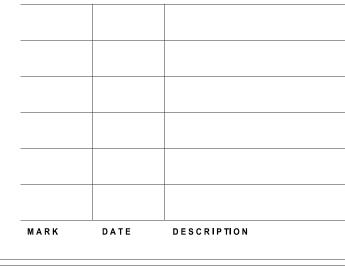

MANAGEMENT INFORMATION.

PROJECT NO:

PRINCIPAL TIM PROJECT DANA IN CHARGE: OLSON ARCHITECT: PEDERSEN

DRAWN BY: HRH CHECKED BY: DLP

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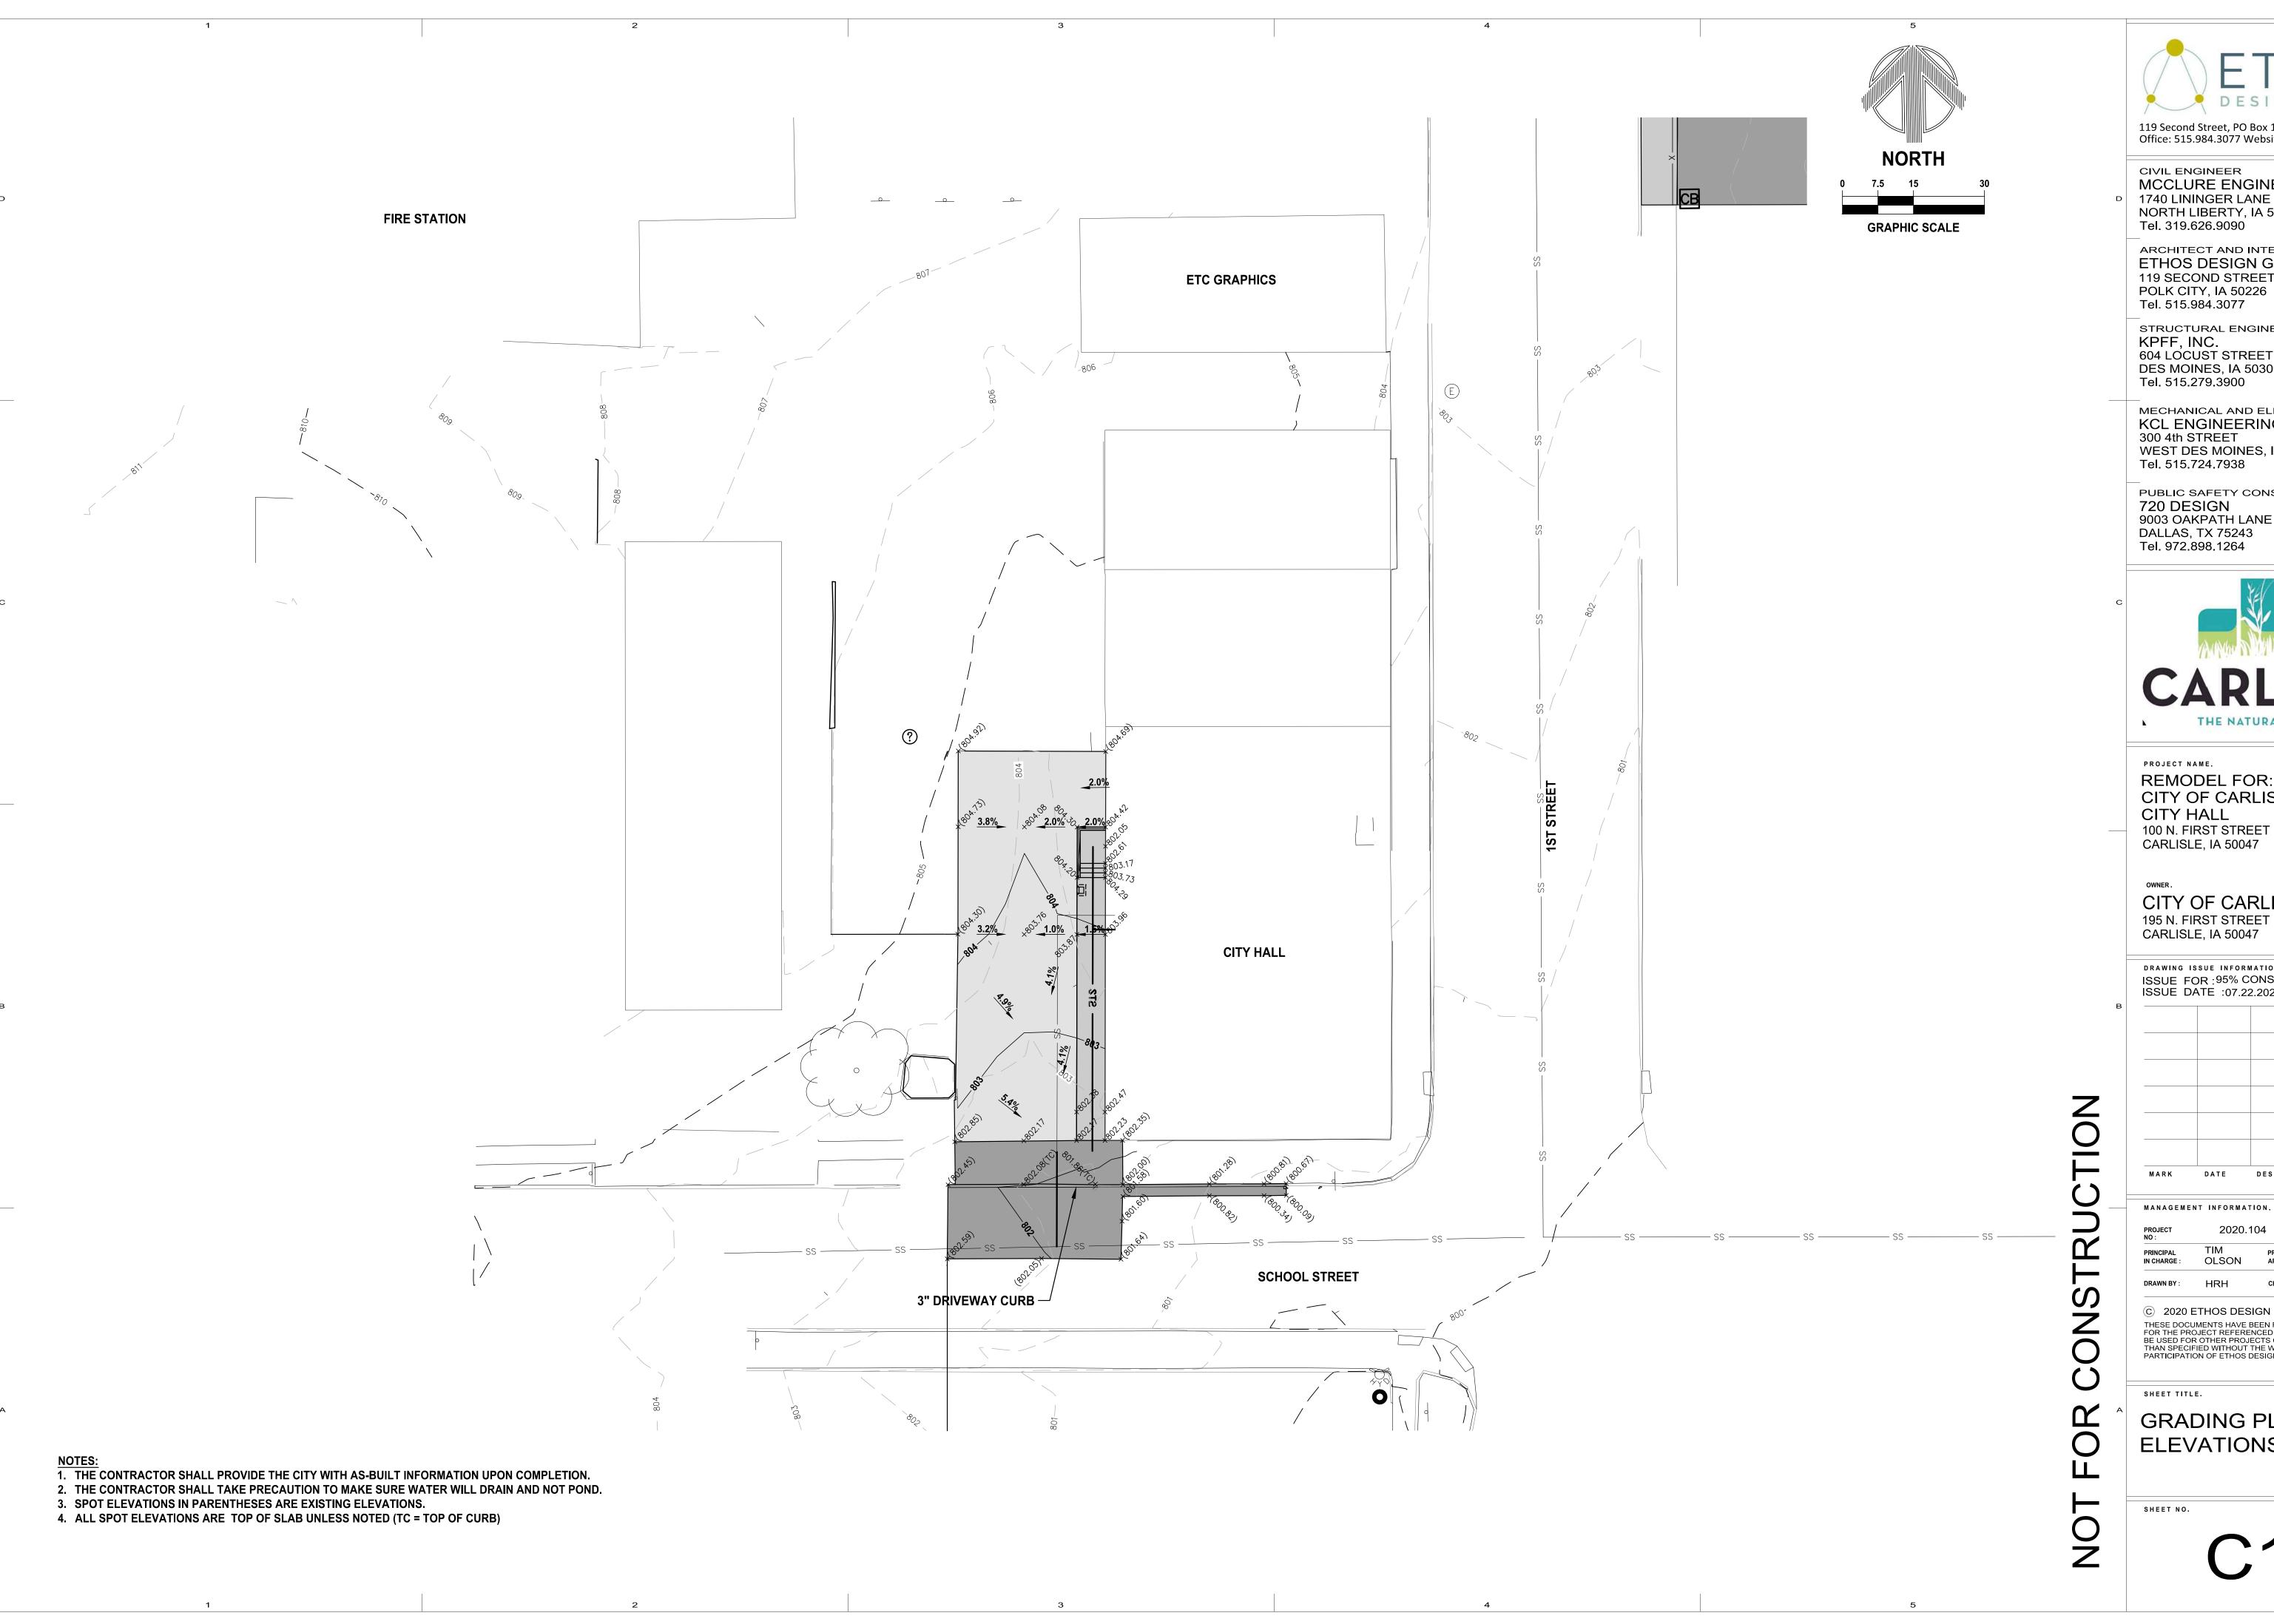
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SHEET TITLE

SITE PLAN AND UTILITIES

SHEET NO.

C101





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REMODEL FOR: CITY OF CARLISLE 100 N. FIRST STREET

CITY OF CARLISLE 195 N. FIRST STREET CARLISLE, IA 50047


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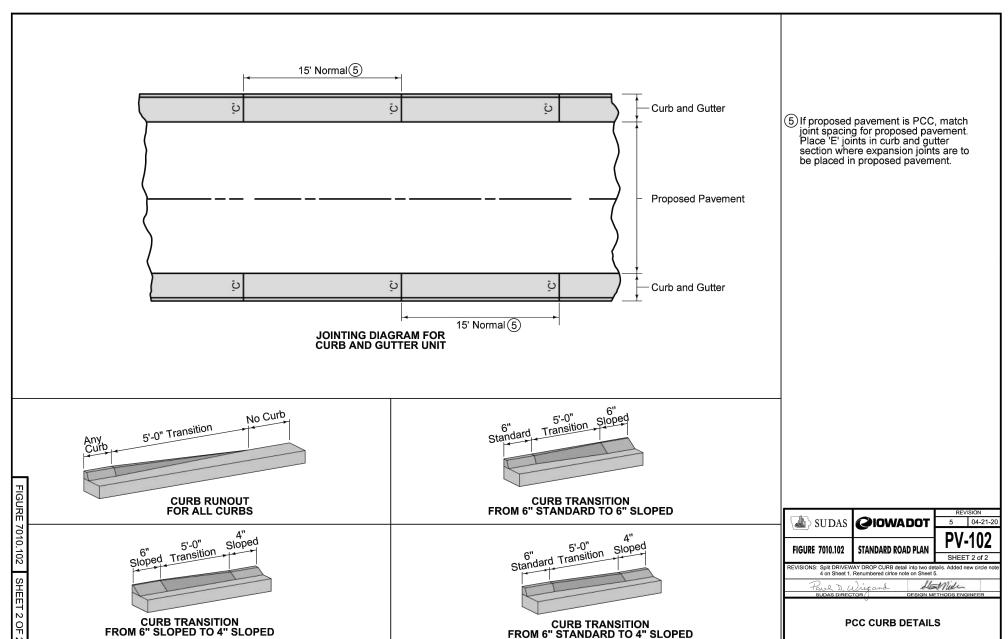



2020.104 PROJECT PEDERSEN OLSON ARCHITECT: CHECKED BY: DLP


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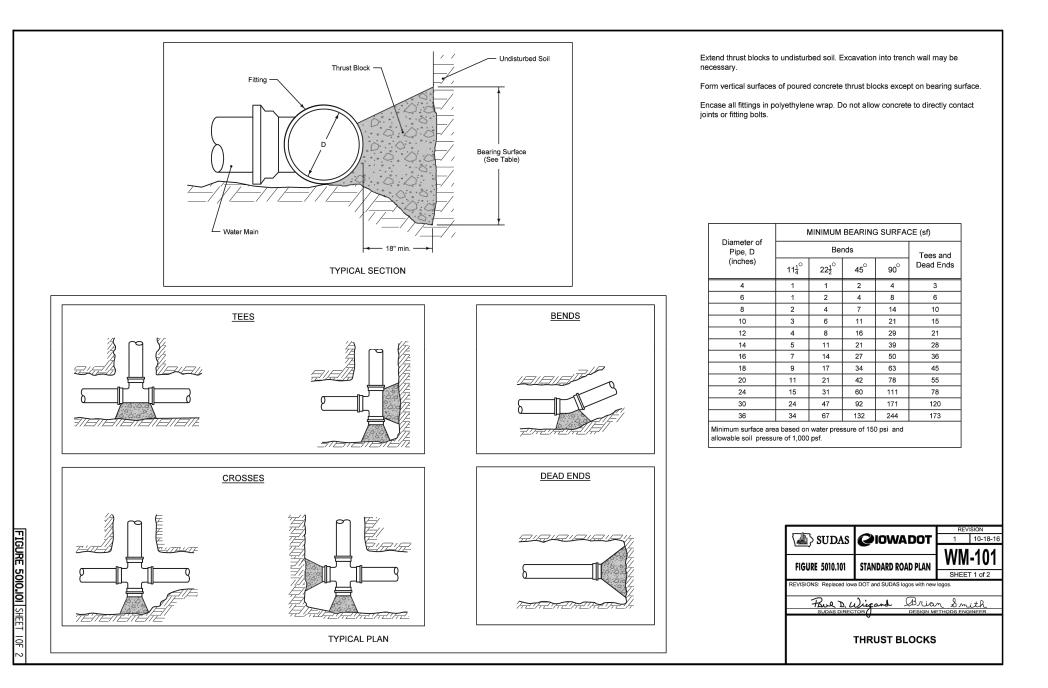
GRADING PLAN AND ELEVATIONS






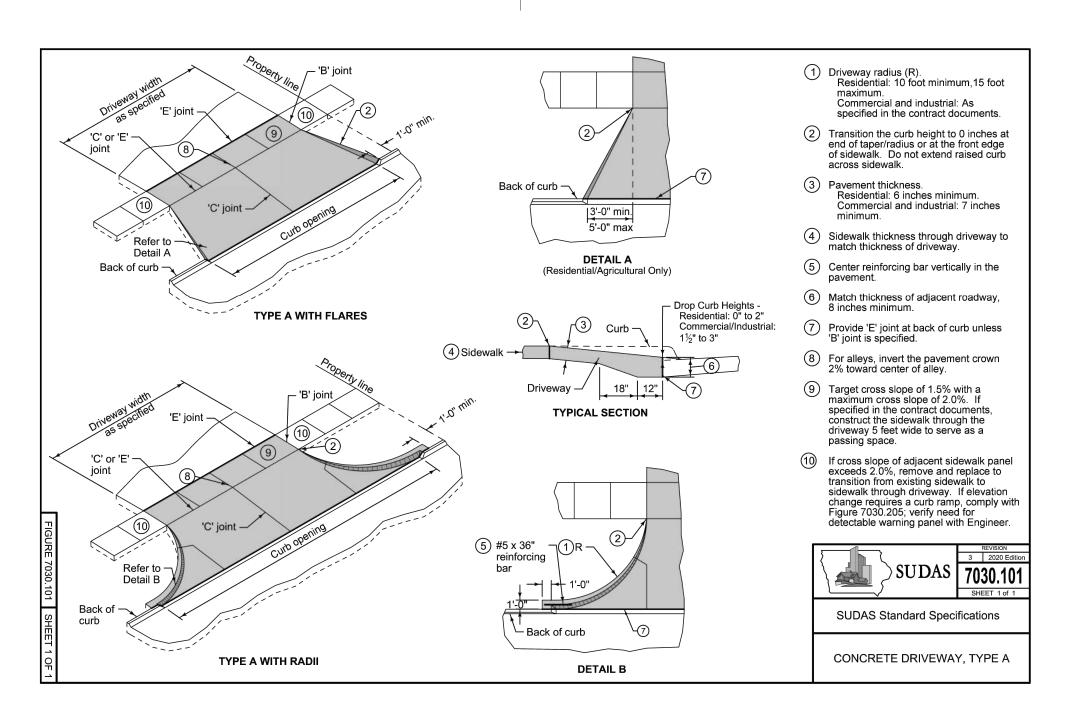

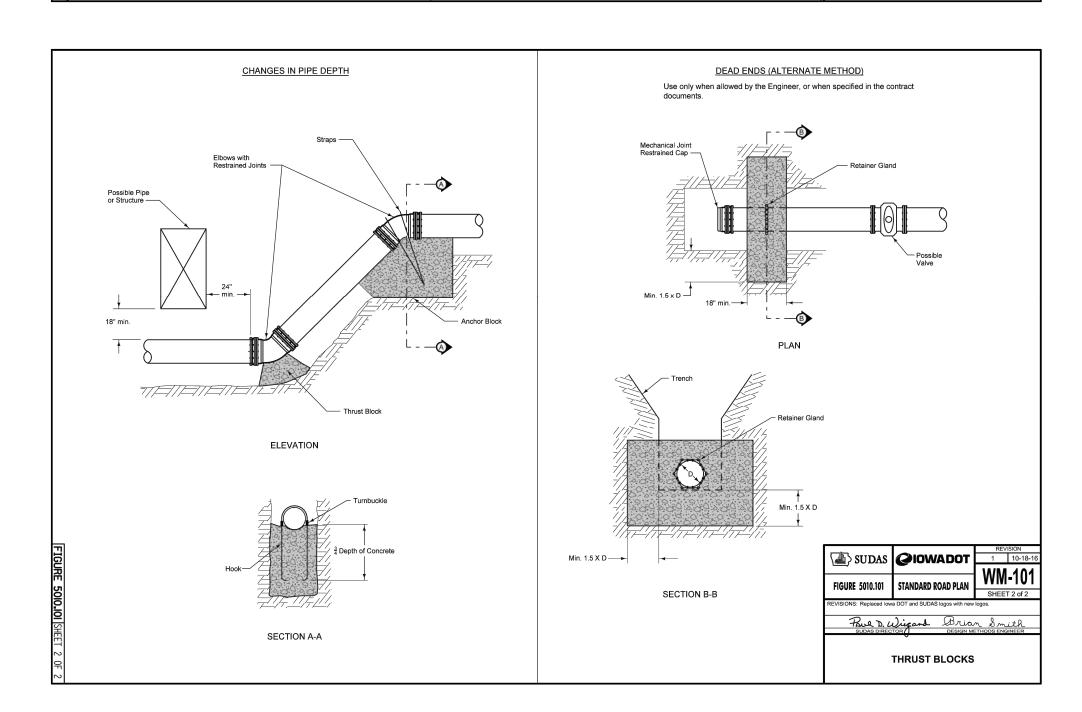

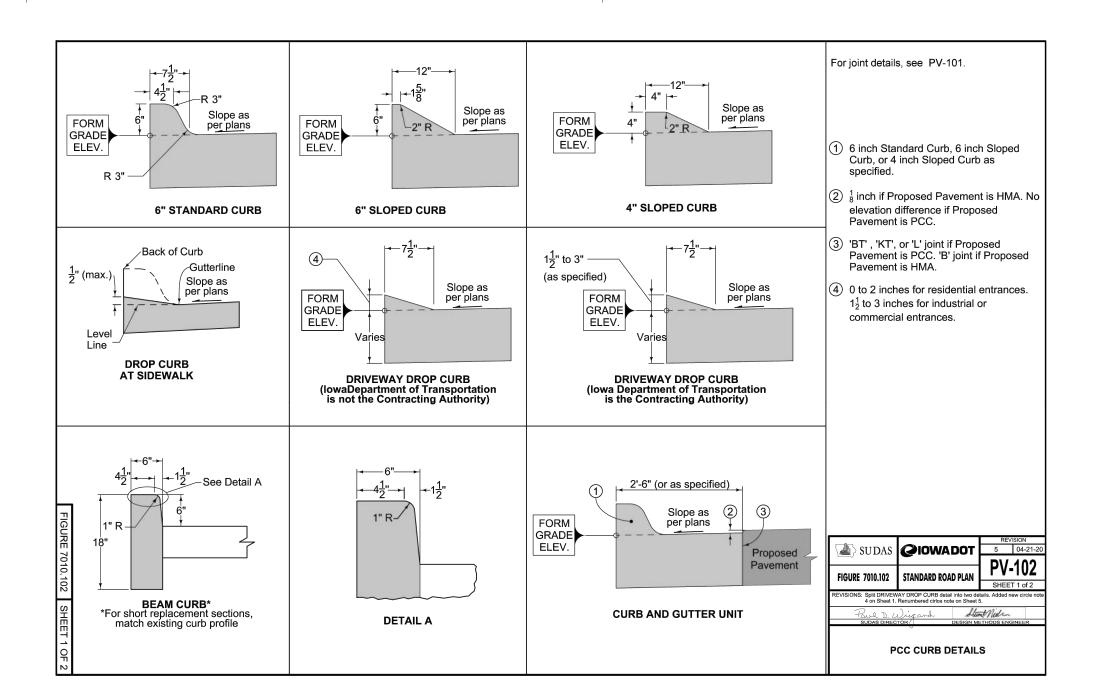

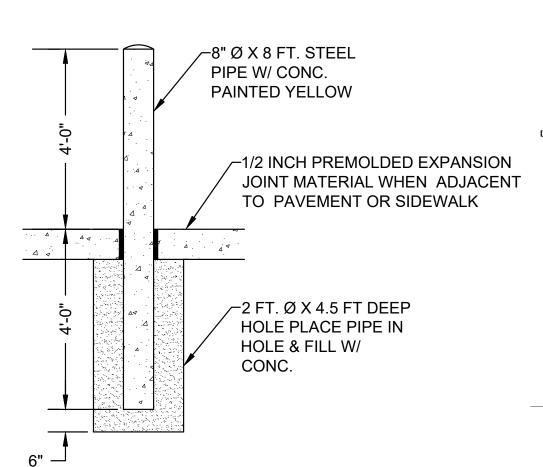

BOLLARD DETAIL

NO SCALE



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MCCLURE ENGINEERING CO.

1740 LININGER LANE
NORTH LIBERTY, IA 52317
Tel. 319.626.9090

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STRUCTURAL ENGINEER
KPFF, INC.
604 LOCUST STREET, SUITE 202
DES MOINES, IA 50309
Tel. 515.279.3900

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KCL ENGINEERING
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WEST DES MOINES, IA 50265
Tel. 515.724.7938

PUBLIC SAFETY CONSULTANT 720 DESIGN 9003 OAKPATH LANE DALLAS, TX 75243 Tel. 972.898.1264



REMODEL FOR:
CITY OF CARLISLE
CITY HALL
100 N. FIRST STREET
CARLISLE, IA 50047

OWNER.

CITY OF CARLISLE


195 N. FIRST STREET

CARLISLE, IA 50047

DRAWING ISSUE INFORMATION.

ISSUE FOR:95% CONSTRUCTION DOCS

ISSUE DATE:07.22.2020

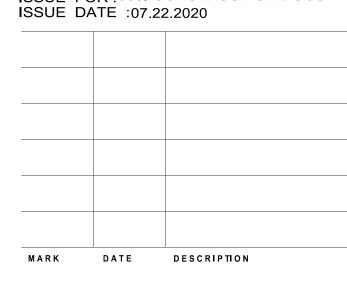

PROJECT 2020.104

PRINCIPAL TIM PROJECT DANA IN CHARGE: OLSON ARCHITECT: PEDERSEN

DRAWN BY: HRH CHECKED BY: DLP

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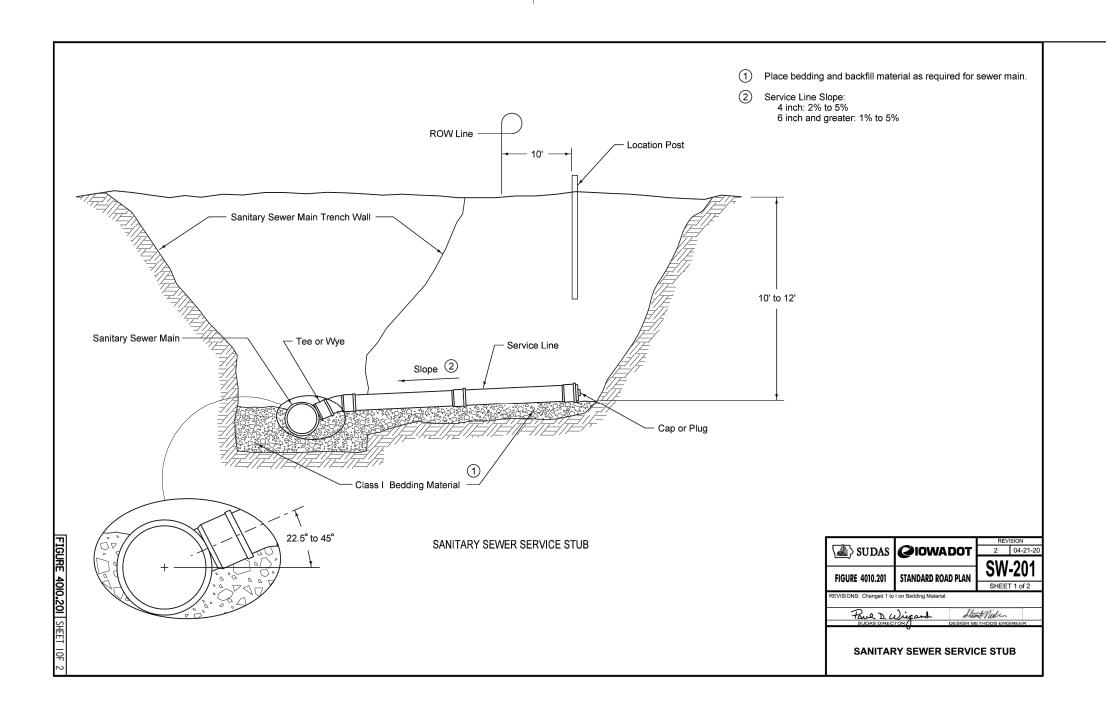
ET TITLE.


MANAGEMENT INFORMATION.

CIVIL DETAILS

SHEET NO.

C103



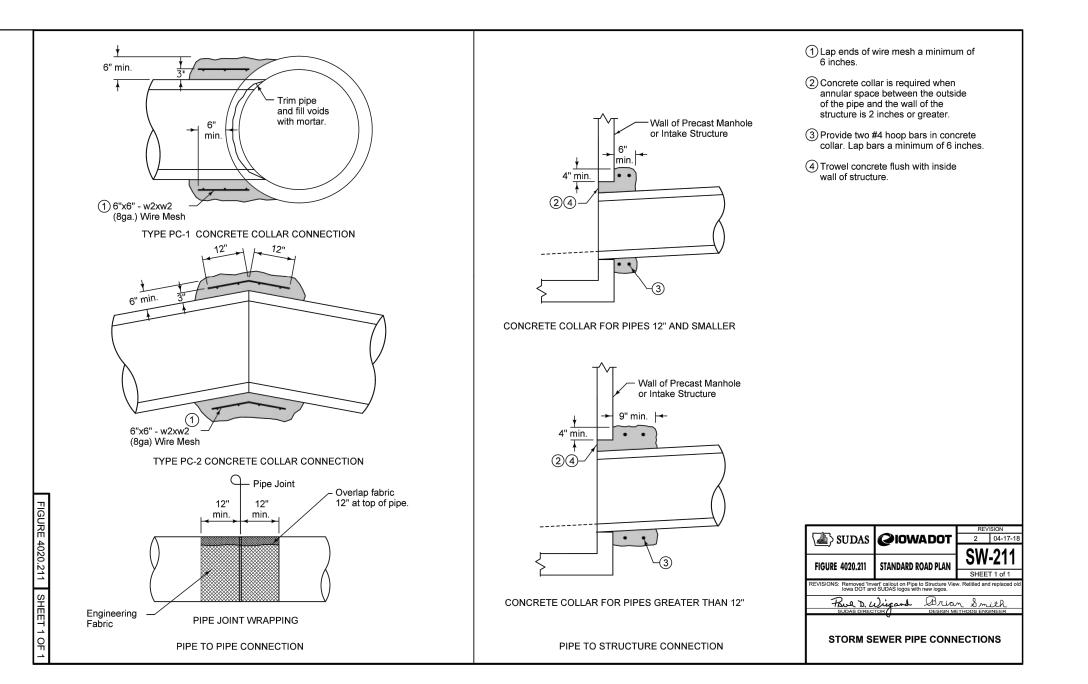



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1740 LININGER LANE
NORTH LIBERTY, IA 52317
Tel. 319.626.9090

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REMODEL FOR:
CITY OF CARLISLE
CITY HALL
100 N. FIRST STREET
CARLISLE, IA 50047


OWNER.

CITY OF CARLISLE

195 N. FIRST STREET

CARLISLE, IA 50047

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ISSUE FOR:95% CONSTRUCTION DOCS
ISSUE DATE:07.22.2020

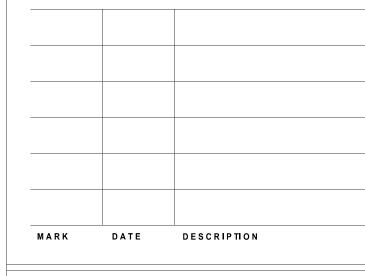

PRINCIPAL TIM PROJECT

DRAWN BY: HRH CHECKED BY: DLP

DANA

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HEET TITLE.

CIVIL DETAILS

SHEET NO.

C104







NEW METAL SOFFIT

ACP-2 ON NEW WRB

ON NEW SHEATHING

ON EXIST. FRAMING

ACP-1 ON NEW WRB ON NEW

SHEATHING ON EXISTING

NEW METAL FASCIA ON

NEW WRB ON NEW SHEATHING

ON EXISTING WOOD SOFFIT.


WOOD FRAMING

FRAMING

PANELS ON EXISTING SOFFIT FRAMING





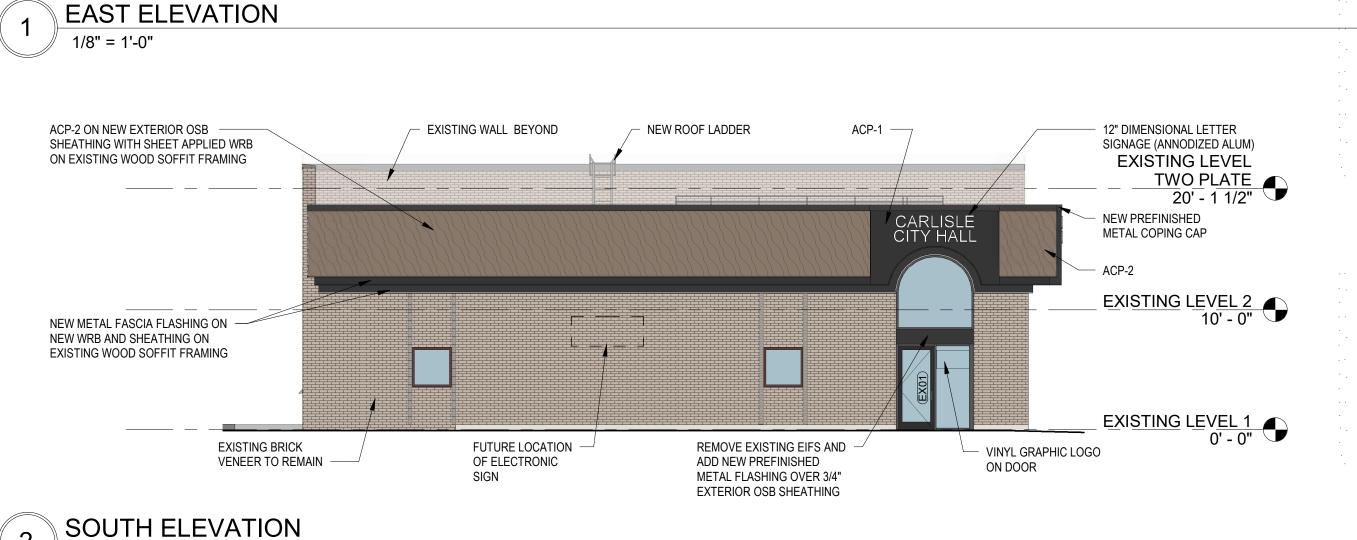

ADD NEW PREFINISHED

METAL FLASHING OVER 3/4"

EXTERIOR OSB SHEATHING

ACP-2 ON NEW EXTERIOR OSB

REPLACE EXISTING SPANDREL

PANEL WITH NEW CLEAR


GLAZING


SHEATHING WITH SHEET APPLIED WRB

ON EXISTING WOOD SOFFIT FRAMING -



<u>PHOTO 16</u>

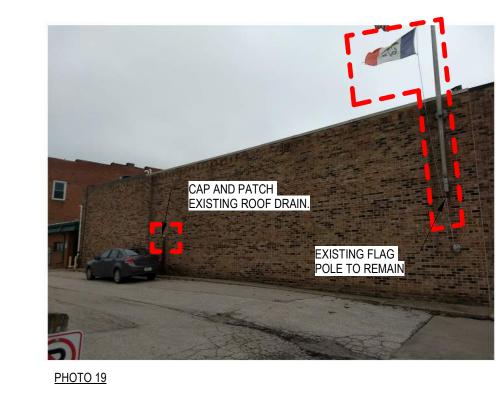

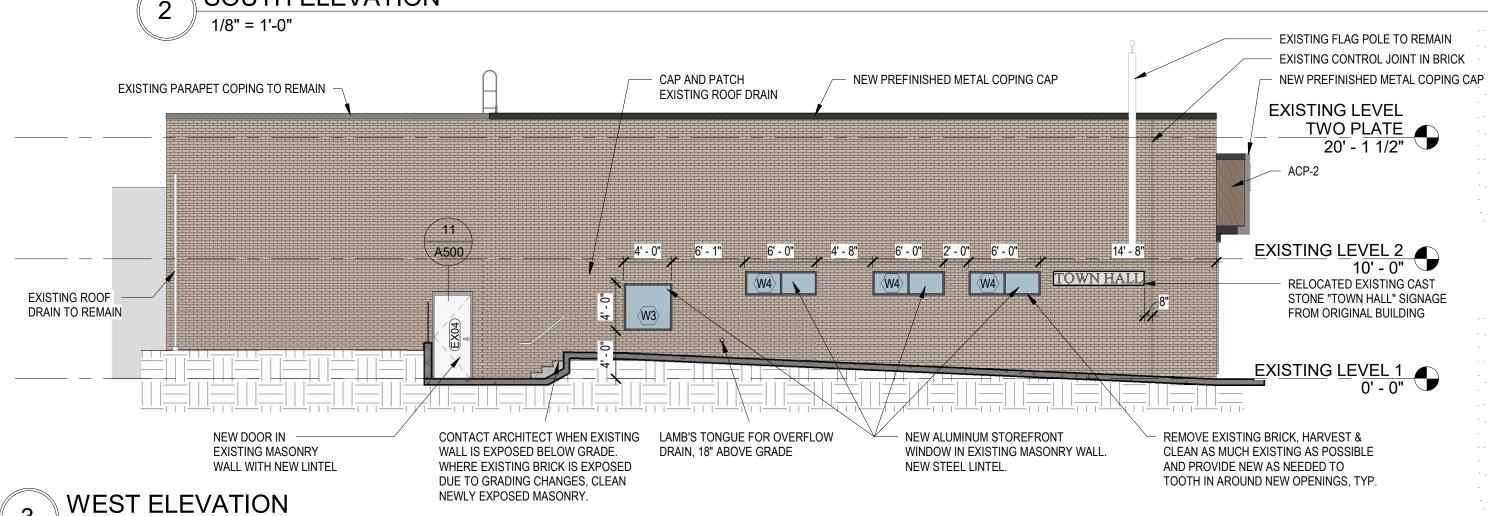



NEW METAL FASCIA FLASHING

ON NEW SHEATHING AND WRB

NEW PREFINISHED

METAL COPING CAP

ON EXISTING WOOD SOFFIT

CARLISLE CITY HALL

12"H DIMENSIONAL

(ANODIZED ALUMINUM)

LETTER SIGNAGE

NEW ALUMINUM

COMPOSITE PANEL

VINYL GRAPHIC LOGO

SURFACE MOUNTED

KNOX BOX ON SIDE WALL


ADD NEW PREFINISHED

METAL FLASHING OVER 3/4"

EXTERIOR OSB SHEATHING

REMOVE EXISTING EIFS AND

ON DOOR

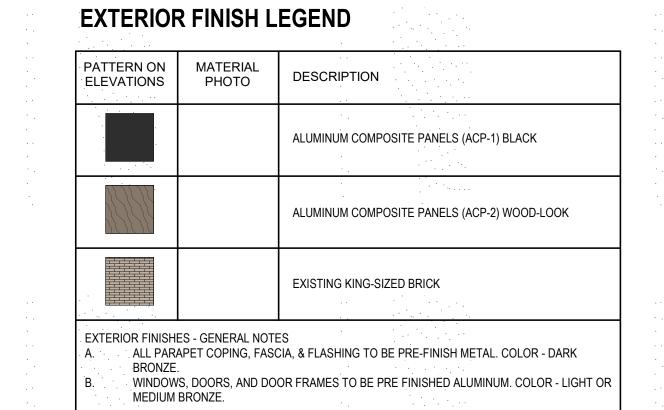

ACP-1

VINYL TEXT: COUNCIL

CHAMBER ENTRANCE

VINYL GRAPHIC LOGO

ON DOOR

TOP MULLION

REPLACE EXISTING WINDOWS WITH NEW

EXISTING LEVEL

EXISTING LEVEL 2

TWO PLATE 20' - 1 1/2"

EXISTING BRICK VENEER TO REMAIN

CURTAINWALL WINDOWS IN EXISTING

OPENING, SPANDRAL GLAZING ABOVE

EXISTING PARAPET COPING TO

EXISTING WALL BEYOND

NEW THRU WALL BILL

DEPOSITORY IN

EXISTING OPENING

REMAIN AT HIGH ROOF ONLY

Ž

119 Second Street, PO Box 169 Polk City, IA 50226 Office: 515.984.3077 Website: www.ethos.archi

CIVIL ENGINEER MCCLURE ENGINEERING CO. 1360 NW 121ST CLIVE, IA 50325 Tel. 515.964.1229

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MECHANICAL AND ELECTRICAL ENGINEER KCL ENGINEERING 300 4th STREET WEST DES MOINES, IA 50265 Tel. 515.724.7938

PUBLIC SAFETY CONSULTANT 720 DESIGN 9003 OAKPATH LANE DALLAS, TX 75243 Tel. 972.898.1264



PROJECT NAME. **RENOVATION FOR:** CITY OF CARLISLE **CITY HALL** 100 NORTH FIRST STREET CARLISLE, IA 50047

OWNER CITY OF CARLISLE 195 N. FIRST STREET CARLISLE, IA 50047

	1	
	1.	

DRAWING ISSUE INFORMATION.

ISSUE FOR: 95% CONSTRUCTION DOCUMENTS

MANAGEMENT INFORMATION. PROJECT 2020.103

PROJECT DANA ARCHITECT : PEDERSEN PRINCIPAL TIM OLSON

DRAWN BY : HRH / CDM CHECKED BY : DLP

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SHEET TITLE. **EXTERIOR**

ELEVATIONS

SHEET NO.



<u>PHOTO 20</u>

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